

**COUNTY OF SAN MATEO  
PLANNING AND BUILDING DEPARTMENT**

**DATE:** December 17, 2020

**TO:** Zoning Hearing Officer

**FROM:** Planning Staff

**SUBJECT:** Consideration of a Minor Subdivision, pursuant to Section 7002 of the County Subdivision Regulations to subdivide a 11,780 sq. ft. parcel into four townhouse units and one common interest parcel at 20 Dexter Avenue in the unincorporated North Fair Oaks area of San Mateo County. The project includes the removal of one 30-inch dbh (diameter at breast height) redwood tree.

County File Number: PLN 2020-00097 (Ryan Lai)

**PROPOSAL**

The applicant proposes to subdivide an 11,780 sq. ft. legal parcel into four townhouse units and the airspace above and one common interest parcel as shows in table 1. The purpose of the subdivision is to construct 4 townhomes to be sold off separately. The townhomes would be 3 stories and all units would have a shared access off of Dexter Avenue. One 30-inch (DBH) redwood tree is proposed for removal due to poor health and proximity to the proposed structures.

Table 1 Tentative Parcel Map Proposal	
	Square Footage
Parcel A, Common Interest Parcel	6,544
Unit 1	1,155
Unit 2	1,175
Unit 3	1,175
Unit 4	1,372

**RECOMMENDATION**

Staff recommends approval of the Minor Subdivision, County File Number PLN 2020-00097, based on the required findings and subject to the conditions of approval listed in Attachment A.

## **BACKGROUND**

Report Prepared By: Kanoa Kelley, Project Planner, [kkelley@smcgov.org](mailto:kkelley@smcgov.org)

Applicant/Owner: Ryan Lai

Location: 20 Dexter Avenue, North Fair Oaks. At the intersection of E. Selby Lane and Dexter Avenue

APN: 060-273-140

Parcel Size: 11,780 sq. ft.

Existing Zoning: R-3, S-5 (Multiple Family Residential, Minimum Lot size 5,000 sq. ft.)

General Plan Designation: Medium High Density Residential, Urban (8.8-17.4 dwelling units/acre)

Parcel Legality: The parcel was developed with a single family residence constructed in 1929.

Sphere-of-Influence: Redwood City

Existing Land Use: Single-Family Residential

Water Service: California Water Service, Bear Gulch

Sewage Disposal: Fair Oaks Sewer Maintenance District

Fire Authority: Menlo Park Fire Protection District

Flood Zone: FEMA Designation: Flood Zone X (Areas of Minimal Flooding), FEMA Panel No. 06081C0302E and 06081C0304E, effective October 16, 2012.

Environmental Evaluation: The project is categorically exempt, pursuant to the California Environmental Quality Act (CEQA) Guidelines, Section 15315 (Class 15), related to minor division of land (into four or fewer parcels), as the division is in conformance with the General Plan and zoning, no variances or exceptions are required, all services and access to the proposed parcels to local standards are available, the parcel was not involved in a division of a larger parcel within the previous 2 years, and the parcel does not have an average slope greater than 20 percent.

Setting: The subject parcel is located at 20 Dexter Avenue in the unincorporated North Fair Oaks area of San Mateo County. The 11,780 sq. ft. parcel is currently developed with a 2,799 square foot triplex, the building remains vacant with no tenants living on site. A building permit to demolish the existing building is currently under review (BLD

2020-00297). The parcel is surrounded by single-family homes in the NMU-1 and R-1 zones (Attachment B- Vicinity Map and Aerial Photo).

## **DISCUSSION**

### **A. KEY ISSUES**

#### **1. Conformance with the General Plan**

The County General Plan designates this area for Medium High Density Residential, which allows for residential development at the density of 8.8-17.4 dwelling units per acre. Based on the allowed density range, 2.37-4.7 units are permitted on the 11,780 (.27 acres) square foot parcel. Therefore, the proposed 4 units are consistent with the general plan density. All public services and infrastructure are available to serve the proposed parcels.

General Plan Policy 8.30 (*Infilling*) encourages the infilling of urban areas where infrastructure and services are available. The project was reviewed by the applicable water and sanitary districts; both districts stated that there is adequate capacity to provide respective service to the additional units. Additionally, the General Plan encourages increasing urban densities by redeveloping underutilized parcels, such as proposed with this project, as it is more cost effective than building new communities and their related infrastructure.

#### **2. Conformance with the North Fair Oaks Community Plan**

The North Fair Oaks (NFO) Community Plan identifies the parcel with a Multi-family Residential land use designation. The multi-family residential designation requires 24-60 dwelling units per acre. While the 0.27-acre parcel would need to supply a minimum of 6.5 units to comply with the NFO Community Plan designation, the project otherwise conforms with General Plan and zoning densities. The NFO Community Plan designation was intended to consolidate the medium-high and high density general plan land use designations. Therefore, while the project does not conform with the specified minimum Community Plan density of 24 units per acre, staff finds that the project is in substantial conformance with the intent of the Community Plan's Multi-family Residential land use designation as the project will result in an increase in the number of entry level housing units available.

#### **3. Compliance with Zoning Regulations**

The subject parcel is zoned R-3/S-5 (Multiple Family Residential/S-5 Combining District). The applicant submitted a footprint analysis that includes the building envelope of the 4 townhouse units (shown in

Attachment C); the building envelope is compliant with R-3/S-5 Zoning Standards as shows in Table 2 below.

The project is exempt from the minimum lot size requirements per Section 7020.2.b of the County Subdivision Regulations which exempts single-family attached residential from these provisions.

Table 2 S-5 Combining District Standards		
	S-5 Development Standards	Proposed
Minimum Site Area	5,000 sq. ft.	11,780 sq. ft. (legal parcel)
Average Width	50 feet	67.49 feet
Minimum Lot Area Per Dwelling Unit	2,500 sq. ft.	2,945 sq. ft.
Minimum Front Setback	20 ft.	20 ft.
Minimum Rear Setback	20 ft.	20 ft.
Minimum Right Side Setback	5 ft.	5 ft.
Minimum Left Side Setback	5 ft.	24 ft.
Maximum Building Height	36 feet/3 stories	34 Feet 3 inches, 3 stories
Maximum Coverage Permitted	50%	35%

Parking Compliance

The townhome development plans show each townhome unit with a two (2) car garage. Per the San Mateo County Zoning Regulations, Chapter 3, Section 6119 (Parking Spaces Required), two (2) spaces are required for each dwelling unit having 2 or more bedrooms. Each of the townhome units will have 3 bedrooms requiring a total of 8 parking spaces. The townhome development will provide 2 covered parking spaces per unit within individual private garages. The anticipated townhome development would conform with County parking requirements.

4. Conformance with Subdivision Regulations

The proposed tentative parcel map (Attachment C) for the minor subdivision has been reviewed by staff under the provisions of the County Subdivision Regulations which implement the Subdivision Map Act (Section 66410, et seq., of the Government Code of the State of California). The County’s

Building Inspection and Drainage Section, Department of Public Works, and the Menlo Park Fire Protection District, Fair Oaks Sewer Maintenance District, and California Water Service have also reviewed the proposed project and found that, as conditioned, it complies with their respective standards.

A preliminary soils report was reviewed and approved by the Planning and Building Department's Geotechnical Section, with a condition that additional analysis would be required during the building permit phase for the residential structures. Additionally, a conceptual drainage plan has been reviewed and approved with conditions by the Drainage Section included in Attachment A to require submittal of a drainage analysis by a registered civil engineer along with the building permit application for the townhomes.

In order to approve this subdivision, the Zoning Hearing Officer must make the following findings as defined in Section 7013.3.b. of the Subdivision Regulations:

Subdivision Findings:

- 1-2. That the proposed map and the design and improvement of the proposed subdivision is consistent with applicable general and specific plans. As discussed in Section A.2 and A.3, the County General Plan designates this area as Medium High Density Residential, 8.8-17.4 dwelling units per acre. The proposed density, after subdivision, would be 14.8 dwelling units per acre, which is within the allowed General Plan range. The North Fair Oaks Community Plan designates the parcel as Multi-family Residential, 24 – 60 dwelling units per acre, however, this community plan designation was intended to consolidate the General Plan land use designations of Medium-High and High Density Residential. Therefore, while the project does not conform with the minimum Community Plan density of 24 units per acre, the project results in an increase in the number of housing units on site and is in substantial conformance with the General Plan and the intent of the NFO Community Plan's Multi-Family Residential land use designation. Additionally, all public services and infrastructure are available to serve the proposed lots.
  
- 3-4. That the site is physically suitable for the type and proposed density of development. The proposed subdivision is in an established residential neighborhood and complies with zoning and general plan density requirements. The site is therefore physically suitable for the type and the proposed density of development. Utility connections are also available to serve future development. The applicant is required to confirm the availability of sewer and water connections for both parcels prior to recordation of the parcel map.

5. That the design of the subdivision or type of improvements is not likely to cause substantial environmental damage or substantially and avoidably injure fish or wildlife or their habitat.

The design of the subdivision and the proposed improvements would not substantially injure fish or wildlife or their habitat, as the site is not located within 100 feet of any water bodies or sensitive habitat areas. Additionally, planning staff has included conditions of approval in Attachment A to require that the project minimize the transport and discharge of pollutants from the project site into local storm drain systems and water bodies by adhering to the San Mateo Countywide Stormwater Prevention Programs and General Construction and Site Supervision Guidelines throughout the duration of subdivision improvements.

6. That the design of the subdivision or type of improvements is not likely to cause serious public health problems. There is no evidence to suggest that the project would create a public health problem or cause substantial environmental damage.
- 7-8. That the design of the subdivision or the type of improvements will not conflict with easements acquired by the public-at-large for access through or use of property within the proposed subdivision. There are no existing access easements on the parcel.
9. That the discharge of waste from the proposed subdivision into an existing community sewer system would not result in violation of existing requirements prescribed by a State Regional Water Quality Control Board pursuant to Division 7 (commencing with Section 13000) of the State Water Code. The Fair Oaks Sewer Maintenance District has indicated that sewer capacity is available.
10. That, since the land is not subject to a Williamson Act Contract, the finding regarding Williamson Act Contract compliance related to sustaining agricultural use is not applicable.
11. That, since the land is not located in a very high fire hazard severity zone or state responsibility area, as defined in Section 51177 of the California Government Code, the project is not subject to the fire safety provisions of Section 7013.3.c.(11)(a-c) of the County Subdivision Regulations.
12. That, since the proposed subdivision does not include land designated in the County General Plan as open space and is not located in a state responsibility area or a very high fire hazard severity zone, the finding regarding consistency with open space purposes and the requirement

for a recorded restriction prohibiting the development of a habitable, industrial or commercial building or structure is not applicable.

13. That pursuant to Section 7005 of the Subdivision Regulations, in carrying out the provisions of the Subdivision Regulations, the County has considered the effect of actions taken pursuant to these regulations on the housing needs of the region and the housing needs of the County as expressed in the Housing Chapter of the County's General Plan and has balanced these needs against the public service needs of residents. The proposed subdivision will support an increase in housing supply in the North Fair Oaks area that is expected to be more affordable as townhome units than individual detached single-family residences.

5. Compliance with In-Lieu Park Fees

Section 7055.3 (Fees In-Lieu of Land Dedication) of the County Subdivision Regulations requires that, as a condition of approval of the tentative map, the sub divider pay an in-lieu fee prior to recordation of the Final Parcel Map. This fee is for acquisition, development or rehabilitation of County parks and recreation facilities, and/or to assist other providers of park and recreation facilities to acquire, develop or rehabilitate facilities that will serve the proposed subdivision. The section further defines the formula for calculating this fee. The fee for this subdivision is \$147,033; however, fees are based on the current land value provided by the County Assessor's Office at the time of payment and are subject to change. A worksheet showing the prescribed calculation is shown in Attachment D.

6. Tree Removal Protection and Replacement

Section 12,2012 of the County Significant Tree Ordinance define a "Significant Tree" as a live woody plant rising above the ground with a single stem or trunk of a circumference of 38 inches or more or 12 inches in diameter measure and 4 1/2 feet vertical above ground. All significant trees require a permit for removal.

The applicant proposes to remove one 30-inch (DBH) redwood tree due to the proximity to the project and the poor health as documented by the arborist report prepared by Kielty Arborist Services, dated November 18, 2019. In order to maximize the use of the parcel and remove risk of property damage, tree removal is requested.

Staff recommends approval of proposed tree removal as the poor health and proximity of the redwood would pose a safety risk and would increase the risk of property damage.

B. NORTH FAIR OAKS COMMUNITY COUNCIL

Due to scheduling conflicts, this item was not considered by the North Fair Oaks Community Council. A notice of public hearing and a copy of the staff report has been provided to the Council.

C. ENVIRONMENTAL REVIEW

The project is categorically exempt, pursuant to the California Environmental Quality Act (CEQA) Guidelines, Section 15315 (Class 15), related to minor division of land (into four or fewer parcels), as the division is in conformance with the General Plan and zoning, no variances or exceptions are required, all services and access to the proposed parcels to local standards are available, the parcel was not involved in a division of a larger parcel within the previous 2 years, and the parcel does not have an average slope greater than 20 percent.

REVIEWING AGENCIES

Department of Public Works  
Building Inspection Section  
Geotechnical Section  
Drainage Section  
Menlo Park Fire Protection District  
Fair Oaks Sewer District  
California Water Service- Bear Gulch District

ATTACHMENTS

- A. Recommended Findings and Conditions of Approval
- B. Vicinity and Aerial Map
- C. Proposed Tentative Parcel Map
- D. In-Lieu Park Fee Worksheet

KAK:cmc – KAKEE0459\_WCU.DOCX



County of San Mateo  
Planning and Building Department

**RECOMMENDED FINDINGS AND CONDITIONS OF APPROVAL**

Permit or Project File Number: PLN 2020-00097      Hearing Date: December 17, 2020

Prepared By: Kanoa Kelley, Project Planner    For Adoption By: Zoning Hearing Officer

**RECOMMENDED FINDINGS**

For the Environmental Review, Find:

1. The project is categorically exempt, pursuant to the California Environmental Quality Act (CEQA) Guidelines, Section 15315 (Class 15), related to minor division of land (into four or fewer parcels), as the division is in conformance with the General Plan and zoning, no variances or exceptions are required, all services and access to the proposed parcels to local standards are available, the parcel was not involved in a division of a larger parcel within the previous 2 years, and the parcel does not have an average slope greater than 20 percent.

For the Minor Subdivision, Find:

- 1-2. That the proposed map and the design and improvement of the proposed subdivision is consistent with applicable general and specific plans. As discussed in Section A.2 and A.3, the County General Plan designates this area as Medium High Density Residential, 8.8-17.4 dwelling units per acre. The proposed density, after subdivision, would be 14.8 dwelling units per acre, which is within the allowed General Plan range. The North Fair Oaks Community Plan designates the parcel as Multi-family Residential, 24 – 60 dwelling units per acre, however, this community plan designation was intended to consolidate the General Plan land use designations of Medium-High and High Density Residential. Therefore, while the project does not conform with the minimum Community Plan density of 24 units per acre, the project results in an increase in the number of housing units on site and is in substantial conformance with the General Plan and the intent of the NFO Community Plan's Multi-Family Residential land use designation. Additionally, all public services and infrastructure are available to serve the proposed lots.

- 3-4. That the site is physically suitable for the type and proposed density of development. The proposed subdivision is in an established residential neighborhood and complies with zoning and general plan density requirements. The site is therefore physically suitable for the type and the proposed density of development. Utility connections are also available to serve future development. The applicant is required to confirm the availability of sewer and water connections for both parcels prior to recordation of the parcel map.
5. That the design of the subdivision or type of improvements is not likely to cause substantial environmental damage or substantially and avoidably injure fish or wildlife or their habitat. The design of the subdivision and the proposed improvements would not substantially injure fish or wildlife or their habitat, as the site is not located within 100 feet of any water bodies or sensitive habitat areas. Additionally, planning staff has included conditions of approval in Attachment A to require that the project minimize the transport and discharge of pollutants from the project site into local storm drain systems and water bodies by adhering to the San Mateo Countywide Stormwater Prevention Programs and General Construction and Site Supervision Guidelines throughout the duration of subdivision improvements.
6. The design of the subdivision or type of improvements is not likely to cause serious public health problems. There is no evidence to suggest that the project would create a public health problem or cause substantial environmental damage.
- 7-8. That the design of the subdivision or the type of improvements will not conflict with easements acquired by the public-at-large for access through or use of property within the proposed subdivision. There are no existing access easements on the parcel.
9. That the discharge of waste from the proposed subdivision into an existing community sewer system would not result in violation of existing requirements prescribed by a State Regional Water Quality Control Board pursuant to Division 7 (commencing with Section 13000) of the State Water Code. The Fair Oaks Sewer Maintenance District has indicated that sewer capacity is available.
10. That, since the land is not subject to a Williamson Act Contract, the finding regarding Williamson Act Contract compliance related to sustaining agricultural use is not applicable.
11. That, since the land is not located in a very high fire hazard severity zone or state responsibility area, as defined in Section 51177 of the California Government Code, the project is not subject to the fire safety provisions of Section 7013.3.c.(11)(a-c) of the County Subdivision Regulations.
12. That, since the proposed subdivision does not include land designated in the County General Plan as open space and is not located in a state responsibility

area or a very high fire hazard severity zone, the finding regarding consistency with open space purposes and the requirement for a recorded restriction prohibiting the development of a habitable, industrial or commercial building or structure is not applicable.

13. That pursuant to Section 7005 of the Subdivision Regulations, in carrying out the provisions of the Subdivision Regulations, the County has considered the effect of actions taken pursuant to these regulations on the housing needs of the region and the housing needs of the County as expressed in the Housing Chapter of the County's General Plan and has balanced these needs against the public service needs of residents. The proposed subdivision will support an increase in housing supply in the North Fair Oaks area that is expected to be more affordable as townhome units than individual detached single-family residences.

## **CONDITIONS OF APPROVAL**

### **Current Planning Section**

1. This approval applies to the proposal, documents and plans described in this report and approved by the Zoning Hearing Officer on December 17, 2020. Minor modifications to the project may be approved by the Community Development Director if they are consistent with the intent of, and in substantial conformance with, this approval.
2. This subdivision approval is valid for two years, during which time a parcel map shall be recorded. An extension to the time period, pursuant to Section 7013.5 of the County Subdivision Regulations, may be issued by the Planning Department upon written request and payment of any applicable extension fees prior to the expiration date.
3. Prior to the recordation of the parcel map, the applicant shall submit a draft of the development's Home Owners Association (HOA) membership agreement with by-laws and Covenants, Conditions and Restrictions (CC&R's) for review and approval by the Community Development Director.
4. Prior to recordation of the parcel map, the applicant shall pay to the San Mateo County Planning and Building Department in-lieu park fees as required by County Subdivision Regulations Section 7055.3. The fees shall be based upon the assessed value of the project parcel at the time of payment and calculated as shown on the worksheet included as Attachment D of this staff report.
5. Prior to recordation of the parcel map, the applicant shall pay to the San Mateo County Planning and Building Department in-lieu park fees as required by County Subdivision Regulations, Section 7055.3. The fees shall be based upon the assessed value of the project parcel at the time of recordation and calculated as shown on the attached worksheet.

6. Prior to the issuance of a building permit for any demolition or future construction, the applicant shall provide an erosion and sediment control plan, which demonstrates how erosion and sediment transport offsite will be minimized during demolition and construction periods. The approved plan shall be implemented prior to issuance of demolition or construction permits and shall be maintained throughout the duration of permitted activities
7. The applicant shall preserve the significant redwood tree proposed for removal until after: 1) The plans submitted for a building permit for each lot demonstrates the necessity to remove the tree and 2) a building permit for construction of the townhome's construction has been issued.
8. Upon future submittal of building permits for the construction of townhomes, the site plan for such development shall include the location and type of one (1) minimum 15-gallon sized native tree. The trees' planting shall be confirmed prior to final inspection approval of the building permit. The applicant may provide such confirmation by emailing photo verification of the planted replacement tree to the Current Planning Section at [planningprojects@smcgov.org](mailto:planningprojects@smcgov.org).
9. During any demolition or future project construction, the applicant is responsible for ensuring that all contractors minimize the transport and discharge of pollutants from the project site into water bodies by adhering to the San Mateo County-wide Stormwater Pollution Prevention Program "General Construction and Site Supervision Guidelines" below:
  - a. Stabilizing all denuded areas and maintaining erosion control measures continuously between October 1 and April 30.
  - b. Removing spoils promptly and avoiding stockpiling of fill materials, when rain is forecast. If rain threatens, stockpiled spoils and other materials shall be covered with a tarp or other waterproof material.
  - c. Storing, handling, and disposing of construction materials and wastes so as to avoid their entry to the storm drain system or water body.
  - d. Avoiding cleaning, fueling or maintaining vehicles on-site, except in an area designated to contain and treat runoff.
  - e. Limiting and timing applications of pesticides and fertilizer to avoid polluting runoff.
10. The applicant shall provide for the extension of water, gas, electric, cable and television lines to service the new lots. All new electrical lines for the proposed subdivision shall be installed from the nearest existing utility pole. The extension of water, gas and electrical lines will require the issuance of a building permit.

11. Noise sources associated with demolition, construction, repair, remodeling, or grading of any real property shall be limited to the hours from 7:00 a.m. to 6:00 p.m., weekdays and 9:00 a.m. to 5:00 p.m., Saturdays. Said activities are prohibited on Sundays, Thanksgiving, and Christmas (San Mateo Ordinance Code Section 4.88.360).
12. Prior to issuance of a demolition or construction permit, a tree protection plan shall be submitted for review and approval in accordance with Section 12,020.4 and 12,020.5 of the County's Significant Tree Ordinance. Additionally, a tree pre-site inspection shall be passed prior to the issuance of a demolition or construction permit to ensure approved tree protection measures, including those recommended by a certified arborist as required by the relevant provisions of the County's Significant Tree Ordinance, have been satisfactorily implemented.

#### Drainage Section

13. The applicant shall have prepared, by a Registered Civil Engineer, a drainage analysis of the proposed subdivision and submit it to the Department of Public Works for review and approval. The drainage analysis shall consist of a written narrative and a plan. The flow of the stormwater onto, over, and off of the property being subdivided shall be detailed on the plan and shall include adjacent lands as appropriate to clearly depict the pattern of flow. The analysis shall detail the measures necessary to certify adequate drainage. Post development flows and velocities shall not exceed those that existed in the predeveloped state. Recommended measures shall be designed and included in the street improvement plans and submitted to the Department of Public Works for review and approval.

#### Geotechnical Section

14. A Geotechnical Report shall be submitted at the time of building permit submittal

#### Department of Public Works

15. Prior to the issuance of the building permit or planning permit (if applicable), the applicant shall submit a driveway "Plan and Profile," to the Department of Public Works, showing the driveway access to the parcel (garage slab) complying with County Standards for driveway slopes (not to exceed 20 percent) and to County Standards for driveways (at the property line) being the same elevation as the center of the access roadway. When appropriate, as determined by the Department of Public Works, this plan and profile shall be prepared from elevations and alignment shown on the roadway improvement plans. The driveway plan shall also include and show specific provisions and details for both the existing and the proposed drainage patterns and drainage facilities.
16. Should the access shown on the plans go through neighboring properties, the

applicant shall provide documentation that "ingress and egress" easements exist providing for this access, prior to issuance of building permit or recordation of map (if any).

17. No proposed construction work within the County right-of-way shall begin until County requirements for the issuance of an encroachment permit, including review of the plans, have been met and an encroachment permit issued. Applicant shall contact a Department of Public Works Inspector 48 hours prior to commencing work in the right-of-way.
18. The applicant shall execute and record an agreement in a form approved by the County for maintenance of street trees, walkways and other improvements in the public right of way.
19. Prior to the issuance of the building permit, the applicant will be required to provide payment of "roadway mitigation fees" based on the square footage (assessable space) of the proposed building per Ordinance #3277.
20. The applicant shall submit a Parcel Map to the Department of Public Works County Surveyor for review, to satisfy the State of California Subdivision Map Act. The final map will be recorded only after all Inter Department conditions have been met.
21. The applicant shall submit written certification from the appropriate utilities to the Department of Public Works and the Planning and Building Department stating that they will provide utility (e.g., sewer, water, energy, communication, etc.) services to the proposed parcels of this subdivision.

#### Building Inspection Section

22. Prior to recordation of the parcel map, the applicant shall apply for and have finalized a demolition permit to demolish the structures and buildings on the property. No demolition activity may occur until a valid permit is issued.

#### Menlo Park Fire Protection District

23. Overhead Electrical Obstruction – Overhead Electrical Utility power lines shall not be located over the aerial fire apparatus access road or between the aerial fire apparatus road and the building.
23. All Emergency Vehicle Access (EVA) Roadways shall be “Publicly Recorded with the County of San Mateo Accessors Office”. As Noted on Sheet T-6 item #5.

24. Fire apparatus roadways, including public and private streets and in some cases, driveways used for vehicle access, shall be capable of supporting the imposed weight of a 75,000 pound (34,050 kg) fire apparatus and shall be provided with an all-weather driving surface. CFC 2016, Appendix D.
25. Private Roadways serving 3 or more residential occupancies shall be all-weather roads with a minimum width of 20 feet and a clear height of 13 feet 6 inches. Roadways shall be designed to accommodate the weight of the fire apparatus and the minimum turning radii of 36 feet for fire apparatus. Dead end roads in excess of 150 feet in length shall be provided with a turn-a-round as specified by CFC Appendix D, Table D103.4.
26. NOTE ON FIELD PLAN: All curbing located within the complex that has not been assigned as onsite parking shall be designated as "No Parking Fire Lane". All fire lanes to comply with Menlo Park Fire Protection District standard for "Designation and Marking of Fire Lane"; since there are only two points of access to the complex.
27. "Entrance Sign B" may be used at each point of access to complex. Provide a complete no parking-fire lane stripping plan with no parking signage in accordance to Menlo Park Fire Protection District standard on subsequent submittal:
  - a. Roadway width for project illustrated at 20 feet wide and shall require curb stripping with no parking signage as per Menlo Park Fire Protection District Standard.
  - b. Required no parking signage installed at an approved location at entrances.
28. Building is illustrated on provided plans as a 29 feet 6-inch building height. The illustrated 20 foot wide driveway will meet Menlo Park Fire Protection District requirement for fire apparatus access.
29. Traffic Opticom Signal Preemption System required for all traffic intersections controlled with a traffic signal. An encroachment permit shall accompany these installations.
30. Applicant to provide fire flow information through a separate engineered plan showing how this is to be achieved. This document shall be submitted to Menlo Park Fire Protection District for review and approval prior to issuance of grading and building permits. CFC 2016, Sec. 507.5.1 Appendix B Section 105.2 and Table 105.1
31. A Public hydrant is required at driveway entrance on East Selby Lane. All hydrant(s) to comply to the following: (show on all subsequent submittals which shall include Civil Utility Sheets)

- a. All fire hydrants shall be wet barrel standard steamer type with 1-4 1/2" (114.3 mm) and 2-2 1/2" (63.5 mm) outlets. Menlo Park Fire Protection District CFC Sec. 507.5.1 Appendix C
32. Fire hydrants and fire appliances (fire department connections and post indicator valves) shall be clearly accessible and free from obstruction. FDC shall be located next to driveway entrance fronting East Selby Lane.
33. For single story buildings or structures with an interior height of up to 18 feet as measured from the finished floor to the underside of ceiling, the minimum sprinkler design shall be 0.18 gpm over the most remote 3,000 sq. ft. area plus 500 gpm hose stream included at the base of the riser. For buildings or structures with an interior height of over 18 feet from finished floor to the underside of the ceiling, the minimum sprinkler design shall be 0.33 gpm over the most remote 3,000 sq. ft. area plus 500 gpm for hose streams included at the base of the riser. With written approval from the fire code official, schools, churches and similar occupancies which have few hazards and are unlikely to change may use lesser sprinkler design densities allowed by NFPA 13 and Chapter 9 of the Fire Code.
34. An approved Fire Sprinkler System shall be installed throughout structure. Fire sprinkler system shall be designed to provide 15gpm/ 1,500 sq. ft. of coverage area, plus hose stream allowance. Fire sprinkler system to comply with NFPA 13 2016 edition and Menlo Park Fire Protection District Standards. A separate plan review fee will be collected upon review of these plans:
  - a. Each floor level shall have a dedicated sprinkler riser assembly installed enabling fire department personnel direct access. The buildings 1st, 2nd, and 3rd floors sprinkler riser assembly to be located in an approved room or closet.
35. An approved fire alarm system is required. A minimum of two sets of plans, specifications and other information pertinent to the system must be submitted to the Menlo Park Fire Protection District for review and approval prior to installation. A separate plan review fee will be collected upon review of these plans:
  - a. Fire alarm systems shall be U.L. Certificated, Certificate of Completion and other documentation listed the National Fire Alarm Code shall be provided for all new fire alarm system installations.
36. The amount of demolition shall not exceed that which is shown on the approved plans. Any additional demolition beyond that which is shown, will require revised plans to be submitted for review and approval by the Building Inspection Section and the Menlo Park Fire Protection District.
37. Approved numbers or addresses shall be placed on all new and existing buildings in such a position as to be plainly visible and legible from the street or road fronting



the property. Said numbers shall contrast with their background. Individual suite numbers shall be permanently posted on the main entrance doors of tenant spaces. If rear outside doors to tenant spaces are installed, they shall include the installation of numerical address numbers corresponding to front addressing. Numbers on new occupancies shall comply with the following:

- a. Structures up to 50 feet (15240 mm) in height shall have addresses with a min. 1-inch (25.4 mm) stroke wide by min. 8 inches (203.2 mm) high.
38. CFC Section 510, Emergency Responder Radio Coverage. When required by the fire code official, all new buildings shall have approved radio coverage for emergency responders within the building based upon the existing coverage levels of the public safety communication systems within Menlo Park Fire Protection District at the exterior of the building. This section shall not require improvements of the existing public safety communication systems.
39. Provide an emergency power disconnect (EPO) at the building main entrance actuated by a "Knox Key Switch", location of the EPO to be positioned adjacent to the required Knox Box.
40. A minimum 2A 10BC rated fire extinguisher shall be located at or near exits and shall be placed so that the travel distance to a fire extinguisher shall not to exceed 75 feet. Verify with Fire Inspector at time of rough inspection to assist with placement of extinguisher(s).
41. Exit signs, emergency lighting, address posting, fire lane, marking, fire extinguishers and Knox Box location to be field verified by Fire Inspector.
42. Means of egress components to include exit pathway throughout use, exit stairwells, exit enclosure providing access to exit doors, door hardware, exit signs, exit illumination and emergency lighting shall comply to CFC/CBC Chapter Ten.
43. The single man door providing direct access to the Sprinkler Riser Assembly shall require signage on the door accessing riser stating- "Riser Room" or agreed upon language.
44. Approved plans and approval letter must be on site at the time of inspection.
45. Final acceptance of this project is subject to field inspection.

#### Fair Oaks Sanitary District

46. The applicant shall purchase an additional 3 sewer connections and obtain all appropriate permits for the installation of the connections. The fees for new sewer connections will be calculated based on the plans submitted prior to final approval of the building plans.

47. Each subdivided parcel must connect to the Sewer District main with an individual 4-inch sewer lateral.
48. The Sewer District will allow the proposed connections providing that all associated fees are paid. The Sewer District may require payment of additional sewer connection fees and sewage treatment capacity fees.
49. The applicant shall submit building plans to the Sewer District for review when the building permit application is submitted. The plans shall indicate the location of the existing and proposed sewer laterals to the Sewer District main.

California Water Service-Bear Gulch District


51. Any improvements to the water system will be at the owners expense including additional services or fire protection needs all storm and sewer lines must have separation from Water of 10 foot horizontal separation and 1 foot vertical separation below the Water main or service line, service lines which go thru one property to another property must have legal easements granted with documentation submitted to Cal Water before installation.

KAKKEE0459\_WCU.DOCX



**County of San Mateo - Planning and Building Department**

# **ATTACHMENT B**

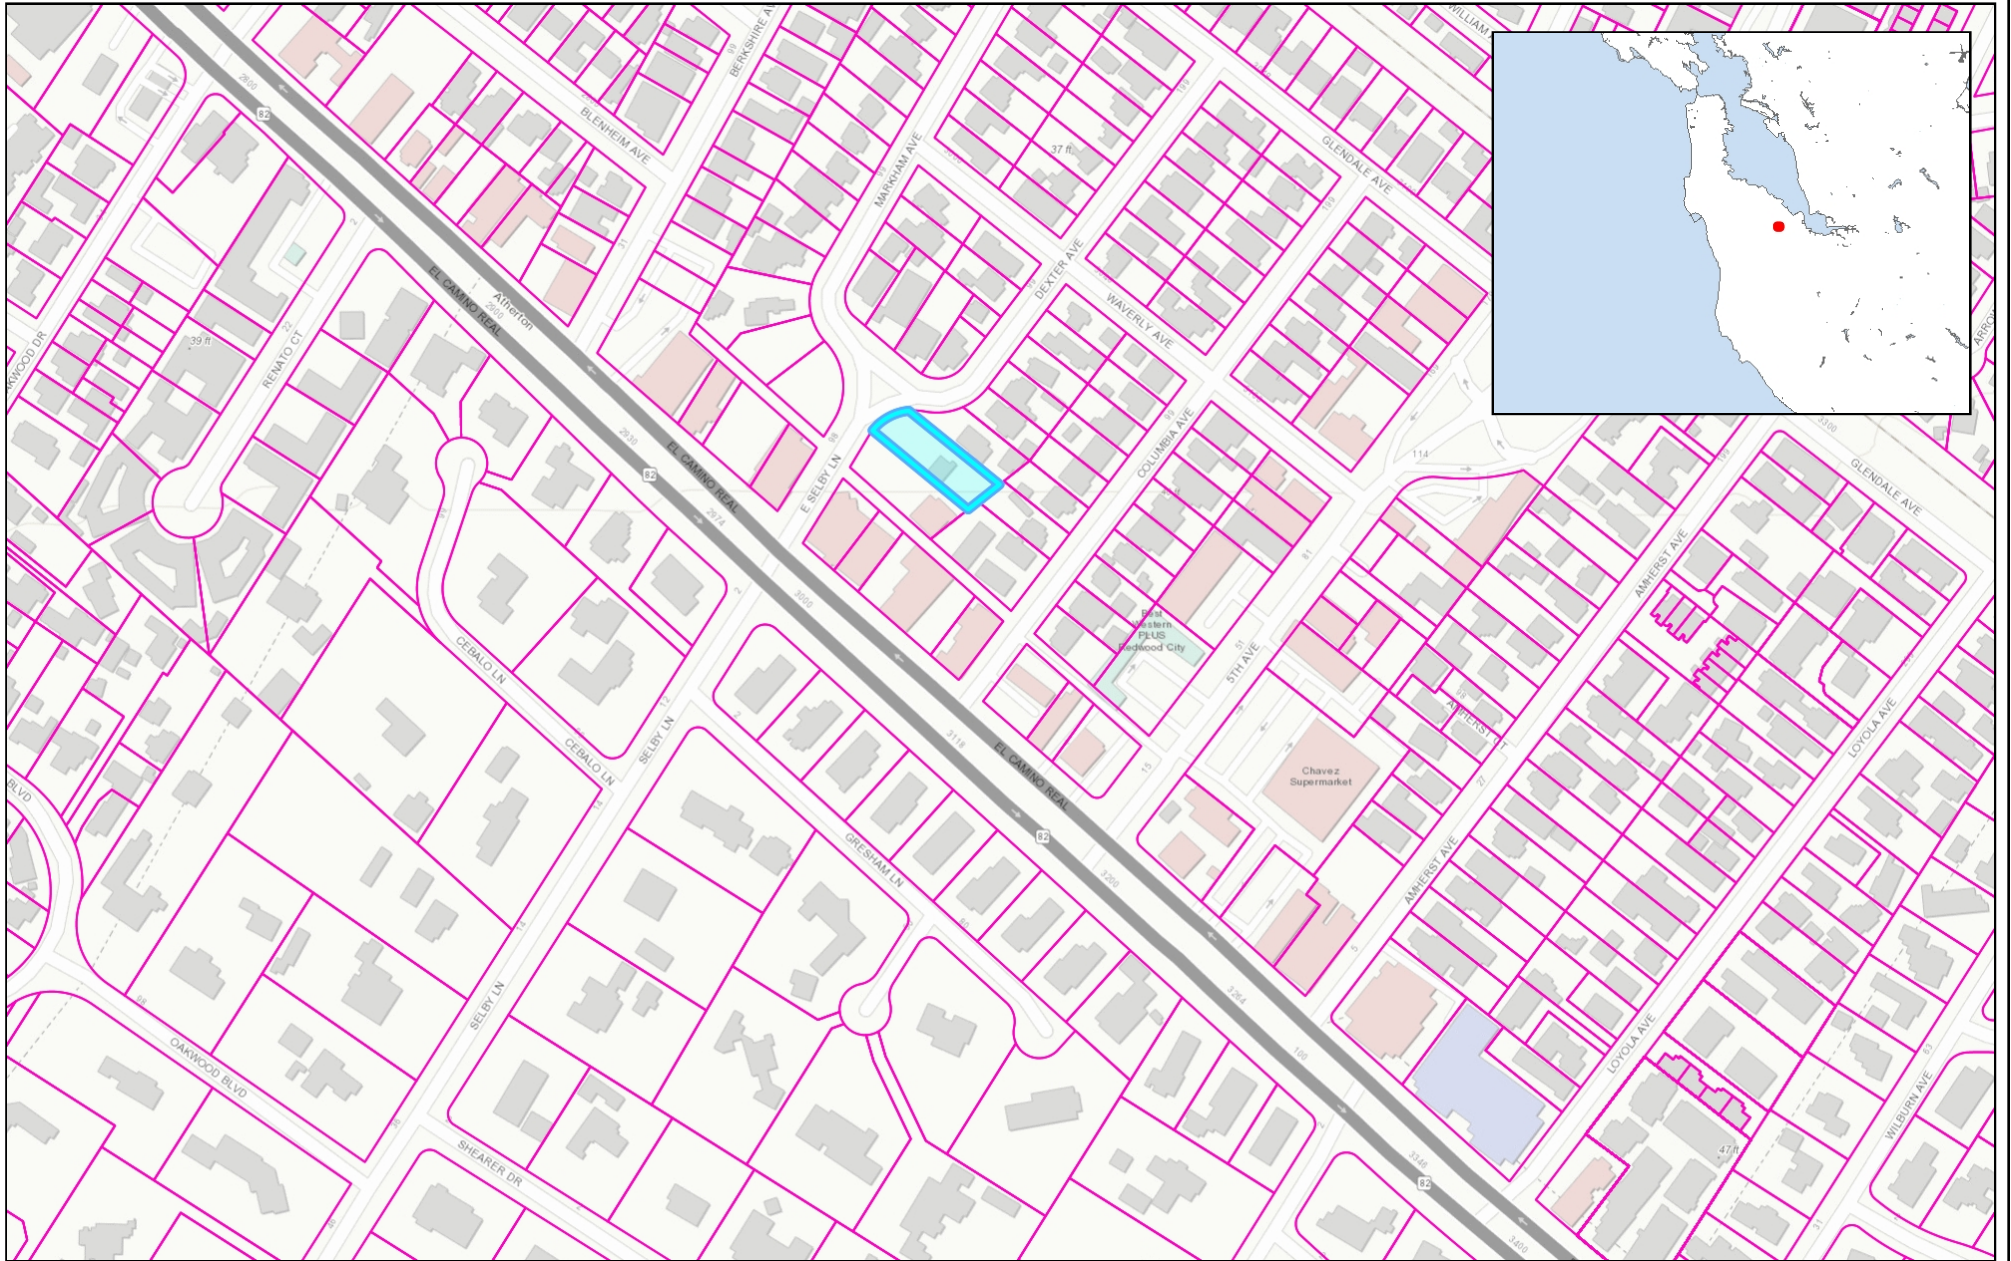

0.14 0 0.07 0.14 Miles



WGS\_1984\_Web\_Mercator\_Auxiliary\_Sphere  
© Latitude Geographics Group Ltd.

1:4,514



This map is a user generated static output from an Internet mapping site and is for reference only. Data layers that appear on this map may or may not be accurate, current, or otherwise reliable.

**THIS MAP IS NOT TO BE USED FOR NAVIGATION**

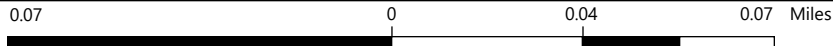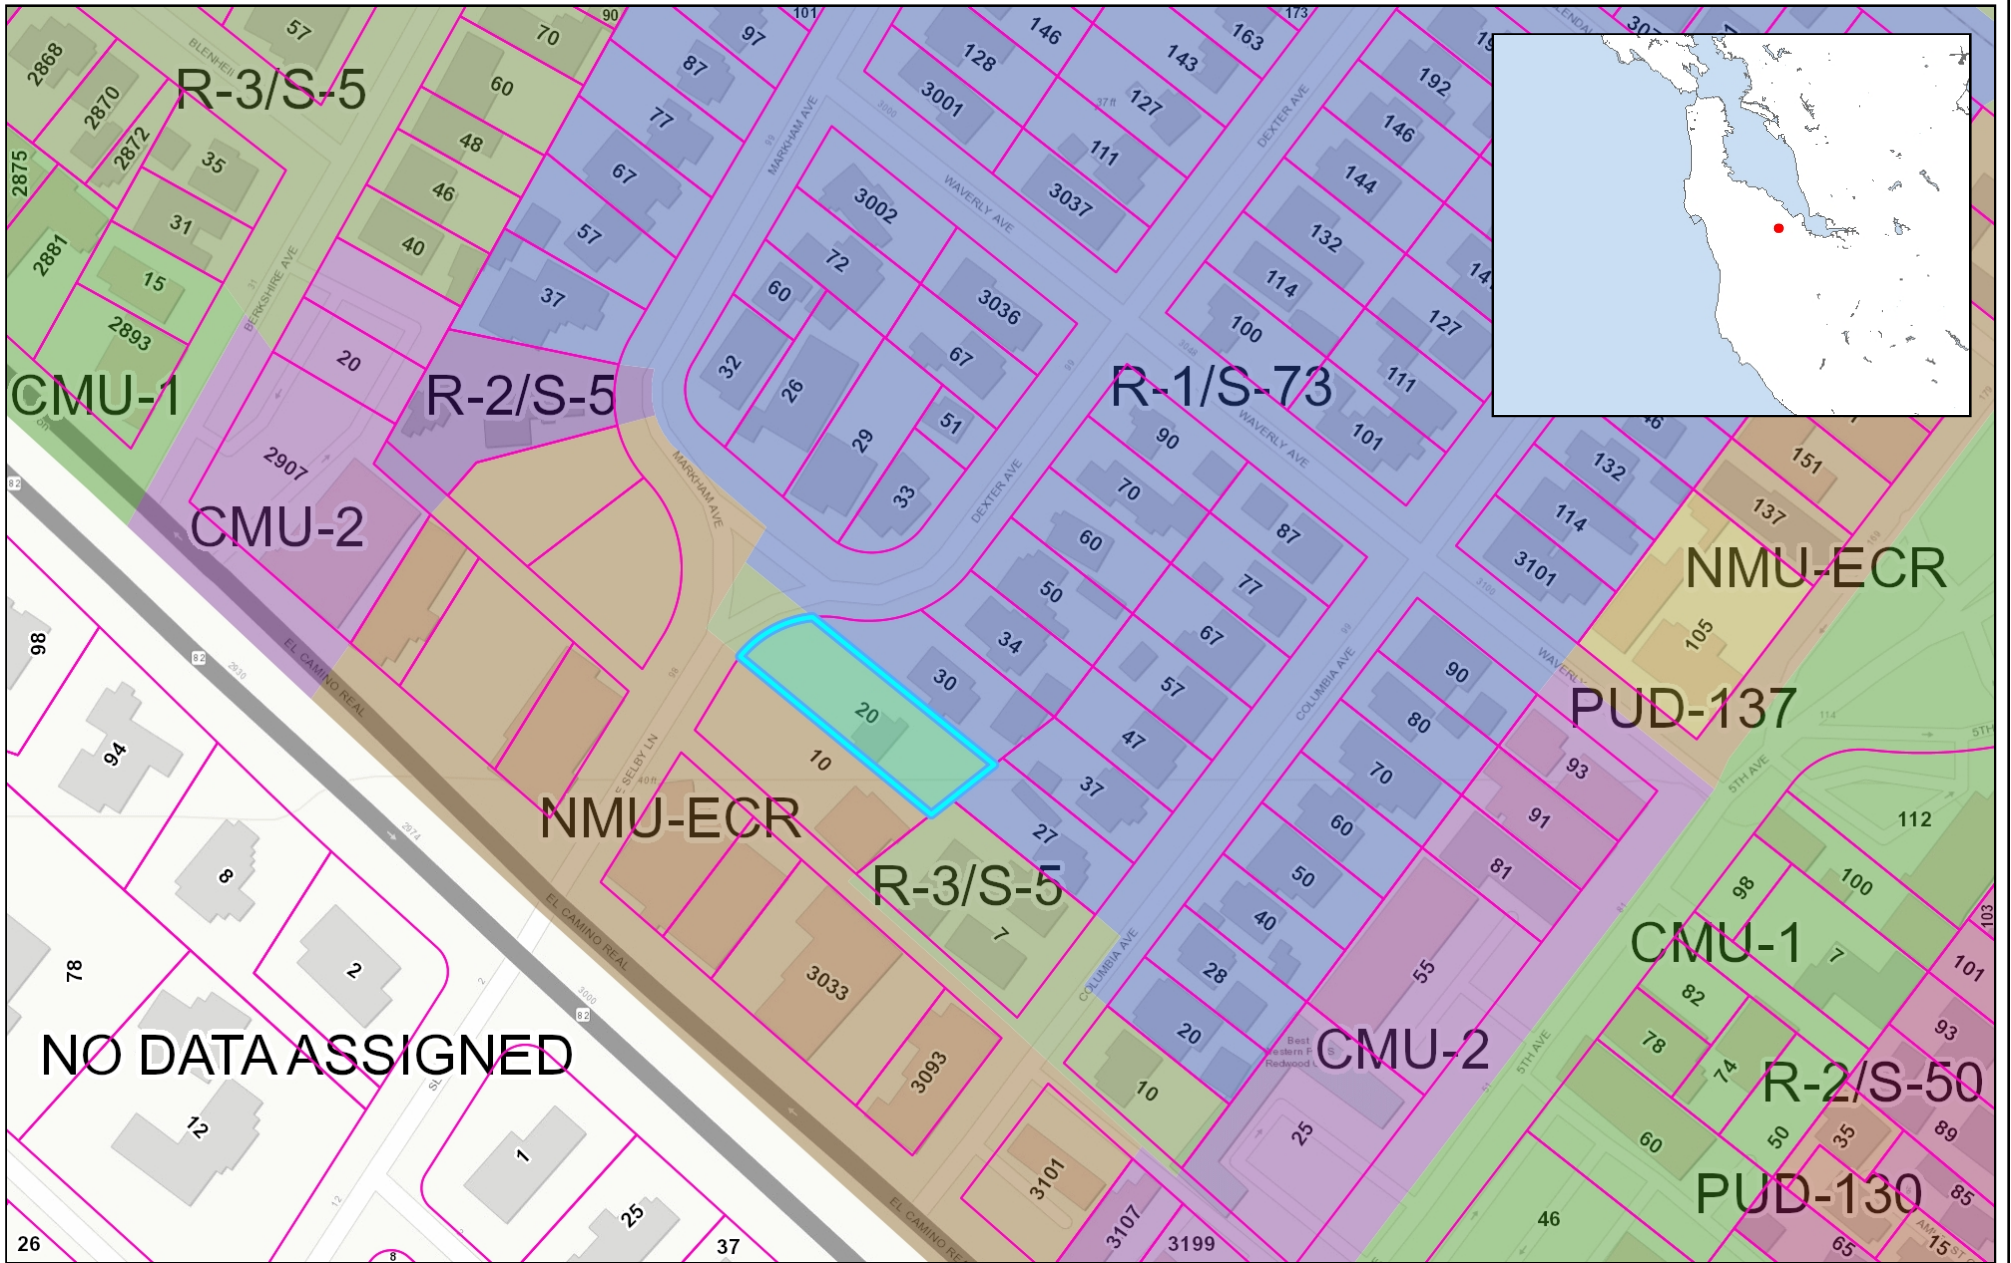

WGS\_1984\_Web\_Mercator\_Auxiliary\_Sphere  
 © Latitude Geographics Group Ltd.

1:2,257

This map is a user generated static output from an Internet mapping site and is for reference only. Data layers that appear on this map may or may not be accurate, current, or otherwise reliable.

**THIS MAP IS NOT TO BE USED FOR NAVIGATION**

An aerial photograph of a residential neighborhood. A blue callout bubble with a white border and a tail pointing to a specific location contains the text "20 Dexter Avenue". The area is densely packed with houses, many with red-tiled roofs, and is interspersed with green trees. A large, multi-story building with a flat roof is visible on the left side, near a road intersection. A parking lot with several cars is located near the center of the image. The overall scene is a typical suburban residential area.

20 Dexter Avenue



**County of San Mateo - Planning and Building Department**

# **ATTACHMENT C**

**20 DEXTER AVENUE  
TENTATIVE MAP LOT SUMMARY**

RESIDENTIAL PARCELS			
LOT/PARCEL NO.	NO. OF LOTS	AREA ACRES	USE
1	1	0.03	LOT FOR SINGLE FAMILY TOWNHOME ATTACHED BUILDING
2	1	0.03	LOT FOR SINGLE FAMILY TOWNHOME ATTACHED BUILDING
3	1	0.03	LOT FOR SINGLE FAMILY TOWNHOME ATTACHED BUILDING
4	1	0.03	LOT FOR SINGLE FAMILY TOWNHOME ATTACHED BUILDING
*A	1	0.15	COMMON AREA RESERVED FOR FUTURE DEDICATION TO HOME OWNERS ASSOCIATION
<b>SUBTOTAL</b>	<b>5</b>	<b>0.27</b>	
<b>TOTAL NUMBER OF DWELLING UNITS</b>		<b>4 TOTAL UNITS</b>	

# 20 DEXTER AVENUE TENTATIVE MAP UNINCORPORATED SAN MATEO COUNTY, CA

**PROJECT INFORMATION**

PROPERTY DESCRIPTION: APN 060-273-140  
EXISTING LAND USE: TWO-STORY RESIDENTIAL BUILDING  
PROPOSED LAND USE: 4 TOWN HOMES AND COMMON AREA

OWNER/SUBDIVIDER: 6021 WEIYING LLC  
20 DEXTER AVENUE  
REDWOOD CITY, CA 94063

ENGINEER: BKF ENGINEERS  
255 SHORELINE DRIVE, SUITE 200  
REDWOOD CITY, CA 94065  
(650)482-6300

ACREAGE: EXISTING 0.27 AC  
PROPOSED 0.27 AC

ZONING: R-3/S-5

STORM DRAIN: SAN MATEO COUNTY (NONE NEAR SITE)

SEWAGE DISPOSAL: SAN MATEO COUNTY

WATER SUPPLY: CALIFORNIA WATER SERVICE


GAS AND ELECTRIC: PG&E

TELEPHONE: AT&T


CABLE: COMCAST

FLOOD ZONE: SITE CURRENTLY FALLS WITHIN AREAS OF MINIMAL FLOOD HAZARD IN ZONE X BASED ON FIRM MAP NUMBER 06081C0302F, DATED APRIL 5, 2019.

SYMBOL	DESCRIPTION	SYMBOL	DESCRIPTION
AB	AGGREGATE BASE	NE	NORTHEAST
AC	ASPHALT CONCRETE	NO., #	NUMBER
AD	AREA DRAIN	NTS	NOT TO SCALE
APN	ASSESSORS PARCEL NUMBER	OC	ON CENTER
APPROX.	APPROXIMATE	OH	OVERHEAD
ARV	AIR RELEASE VALVE	PG&E	PACIFIC GAS AND ELECTRIC
AVL	AVENUE	P/L	PROPERTY LINE
BLDG	BUILDING	PP	POWER POLE
BLVD	BOULEVARD	PRC	POINT OF REVERSE CURVE
BM	BENCH MARK	PRV	PRESSURE REDUCING VALVE
BO	BLOWOFF	PT	POINT
BW	BACK OF WALK, BOTTOM OF WALL	PAE	PUBLIC ACCESS EASEMENT
CB	CATCH BASIN	PVC	POLYVINYL CHLORIDE
CC	CENTER TO CENTER or CENTER OF CURVE	RCP	REINFORCED CONCRETE PIPE
CF	CUBIC FEET	RD	ROAD
C&G	CURB & GUTTER	RT	RIGHT
CIP	CAST IRON PIPE	R/W	RIGHT OF WAY
CL	CENTERLINE	SD	STORM DRAIN
CMP	CORRUGATED METAL PIPE	SDCO	STORM DRAIN CLEAN OUT
CO	CLEANOUT	SDMH	STORM DRAIN MANHOLE
CONC	CONCRETE	SF	SQUARE FEET
CONST	CONSTRUCT	SHT	SHEET
CR	CURB RETURN/RAMP	SS	SANITARY SEWER
CT	COURT	SSCO	SANITARY SEWER CLEANOUT
CY	CUBIC YARD	SSE	SANITARY SEWER EASEMENT
DI	DUCTILE IRON	SSMH	SANITARY SEWER MANHOLE
DIA	DIAMETER	ST	STREET
DIAZ	DIAZ AVENUE	STD	STANDARD
DIP	DUCTILE IRON PIPE	S/W	SIDEWALK
DR	DRIVE	T	TELEPHONE
DWY	DRIVEWAY	TC	TOP OF CURB
(E)	EXISTING	TEMP	TEMPORARY
E	ELECTRICAL	TG	TOP OF GRATE
EA	EACH	TYP	TYPICAL
EL	ELEVATION	UG	UNDER GROUND
EP	EDGE OF PAVEMENT	VCP	VITRIFIED CLAY PIPE
ESMT	EASEMENT	W/	WITH
E.V.A.E.	EMERGENCY VEHICLE ACCESS EASEMENT	WM	WATER METER
EX	EXISTING	WV	WATER VALVE
F/C	FACE OF CURB	W	WATER
FDC	FIRE DEPARTMENT CONNECTION		
FF	FINISHED FLOOR ELEVATION		
FG	FINISHED GRADE		
FH	FIRE HYDRANT		
FI	FIELD INLET		
FL	FLOW LINE		
FS	FINISHED SURFACE		
FT	FEET		
G	GAS		
GALV	GALVANIZED		
GB	GRADE BREAK		
GND	GROUND		
GR	GRADE		
GV	GATE VALVE		
HORIZ	HORIZONTAL		
HP	HIGH POINT		
HV	HIGH VOLTAGE		
ID	INSIDE DIAMETER		
IEE	INGRESS/EGRESS EASEMENT		
IN	INCHES		
INV	INVERT		
JP	JOINT POLE		
JT	JOINT TRENCH		
L	LENGTH		
LAT	LATERAL		
LB	POUND(S)		
LF	LINEAR FEET		
LT	LEFT		
MAX	MAXIMUM		
MH	MANHOLE		
MID	MIDDLE		
MIN	MINIMUM		
MISC	MISCELLANEOUS		
MON	MONUMENT		
N	NORTH		

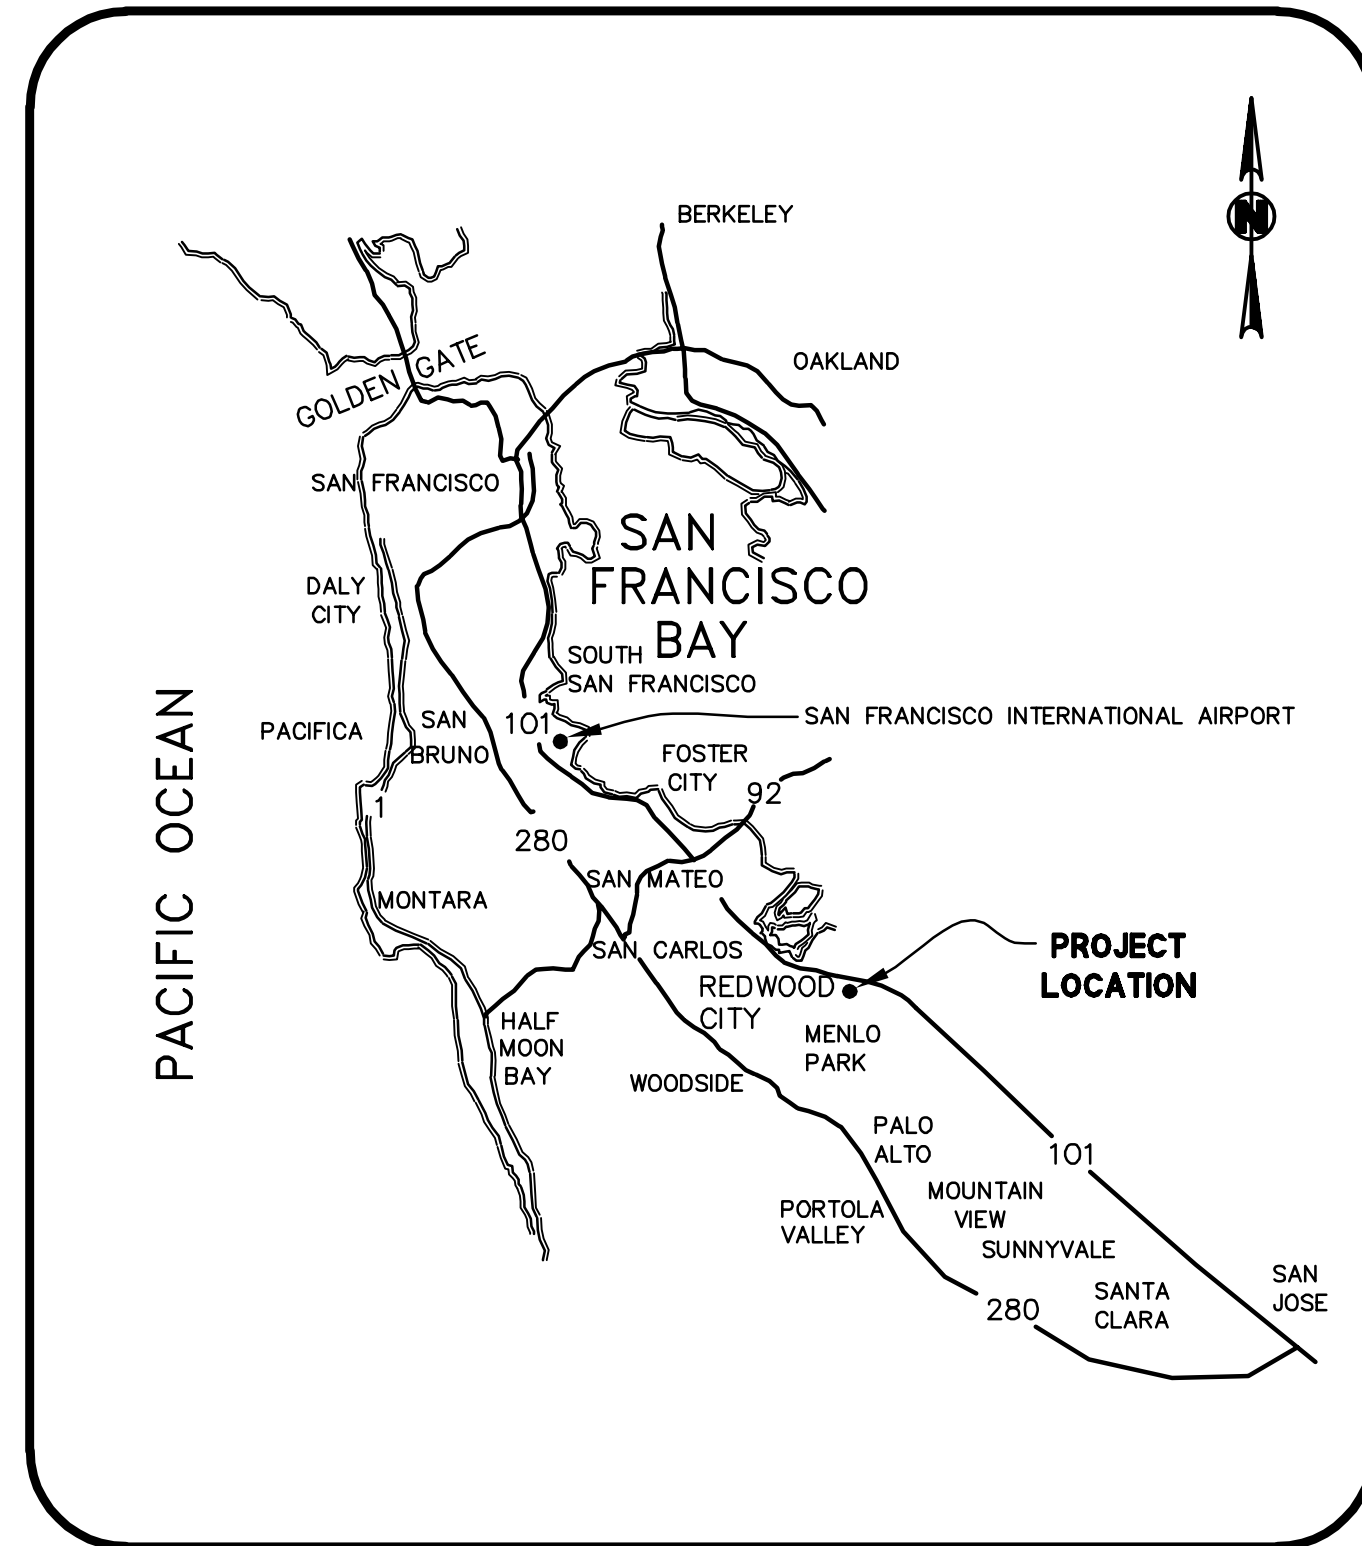

**LOCATION MAP**  
N.T.S.

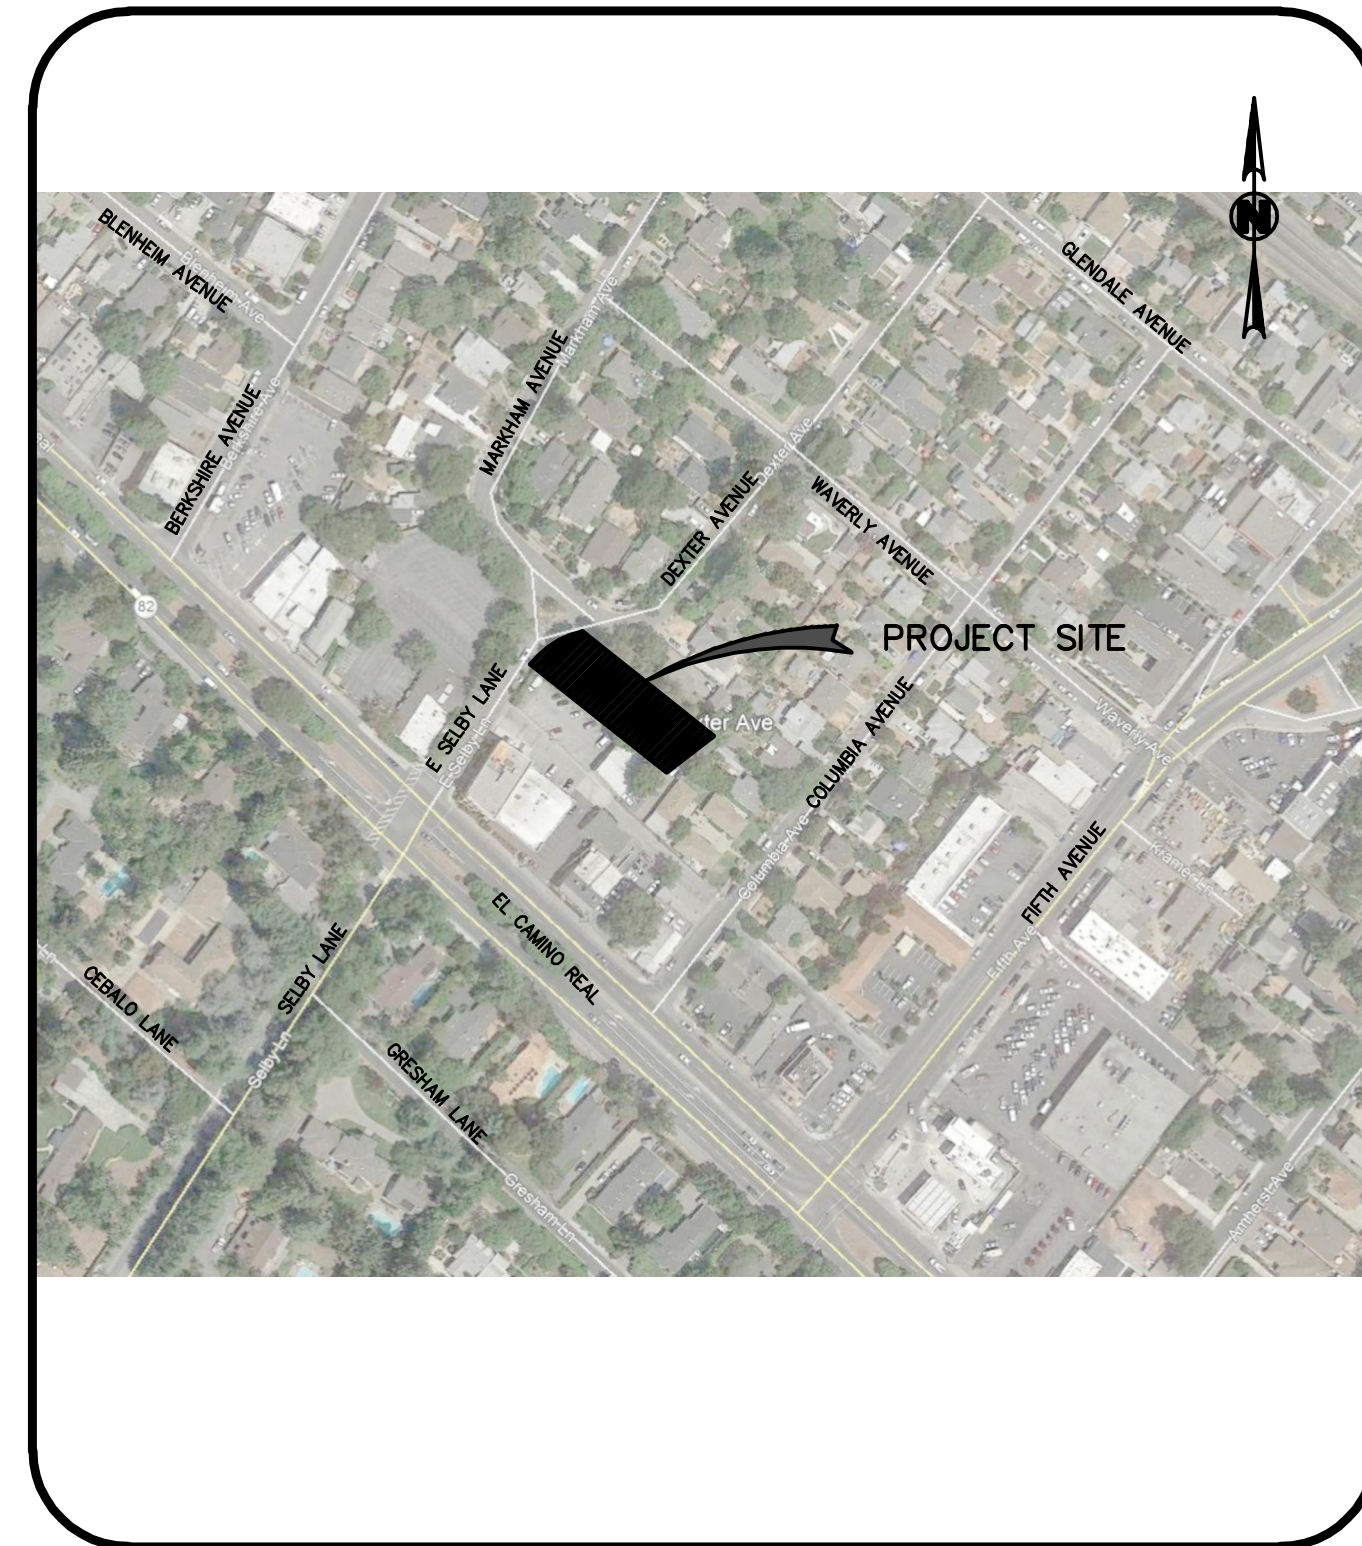

**VICINITY MAP**  
N.T.S.

**LEGEND**

EXISTING	PROPOSED
PROPERTY LINE	---
SANITARY SEWER LINE	SS
ELECTRIC LINE	E
GAS LINE	G
STORM DRAIN LINE	SD
TELEPHONE LINE	T
WATER LINE	W
OVERHEAD LINE	OH
CLEANOUT	CO
MANHOLE	○
FIRE HYDRANT	□
WATER VALVE	□
WATER METER	□

**BENCHMARK:**

THE ELEVATIONS SHOWN ON THIS SURVEY ARE NORTH AMERICAN VERTICAL DATUM OF 1988 (NAVD 88) ELEVATIONS BASED UPON GPS OBSERVATIONS OF BKF POINT NO. 1 PERFORMED BY BKF ON MAY 20, 2019. THE GPS OBSERVATIONS ARE THE RESULTS OF AVERAGED REDUNDANT MEASUREMENTS OF BKF POINT NO. 1 TAKE WITH GNSS EQUIPMENT UTILIZING THE CALIFORNIA SURVEY AND DRAFTING SUPPLY REAL-TIME KINEMATIC REAL-TIME NETWORK (CSDS-RTN), WHICH BROADCASTS REAL-TIME ELEVATIONS ON THE NAVD88 VERTICAL DATUM. PRIOR TO THE ACCEPTANCE OF THIS ELEVATION BY BKF, A PUBLISHED NATIONAL GEODETIC SURVEY (NGS) BENCHMARK OFF-SITE WAS OBSERVED, CHECKED, AND AGED UPON TO STANDARD GNSS SURVEY TOLERANCES FOR A PROJECT OF THIS TYPE (0.05'±).

BKF POINT NO. 1 ELEVATION = 39.08'

**BASIS OF BEARINGS:**

THE BEARING OF NORTH 51°33'40" WEST OF WAVERLY AVENUE AS SHOWN UPON THAT CERTAIN RECORD SUBDIVISION MAP FILED IN VOLUME 13 OF RECORD SUBDIVISION MAPS AT PAGE 20 WAS TAKEN AS THE BASIS OF BEARINGS FOR THIS SURVEY.

**RECORD REFERENCES:**

(R1) RECORD SUBDIVISION MAP FILED JANUARY 20, 1926 IN BOOK 13 OF RSM MAPS AT PAGE 29, SAN MATEO COUNTY RECORDER.

**UNAUTHORIZED CHANGES & USES:**

THE ENGINEER PREPARING THESE PLANS WILL NOT BE RESPONSIBLE FOR, OR LIABLE FOR, UNAUTHORIZED CHANGES TO OR USES OF THESE PLANS. ALL CHANGES TO THESE PLANS MUST BE IN WRITING AND MUST BE APPROVED BY THE PREPARER OF THESE PLANS.

CONSTRUCTION CONTRACTOR AGREES THAT IN ACCORDANCE WITH GENERALLY ACCEPTED CONSTRUCTION PRACTICES, CONSTRUCTION CONTRACTOR WILL BE REQUIRED TO ASSUME SOLE AND COMPLETE RESPONSIBILITY FOR JOB SITE CONDITIONS DURING THE COURSE OF CONSTRUCTION OF THE PROJECT, INCLUDING SAFETY OF ALL PERSONS AND PROPERTY; THAT THIS REQUIREMENT SHALL BE MADE TO APPLY CONTINUOUSLY AND NOT BE LIMITED TO NORMAL WORKING HOURS, AND CONSTRUCTION CONTRACTOR FURTHER AGREES TO DEFEND, INDEMNIFY AND HOLD DESIGN PROFESSIONAL HARMLESS FROM ANY AND ALL LIABILITY, REAL OR ALLEGED, IN CONNECTION WITH THE PERFORMANCE OF WORK ON THIS PROJECT, EXCEPTING LIABILITY ARISING FROM THE SOLE NEGLIGENCE OF DESIGN PROFESSIONAL.

**SHEET INDEX**

T-1	TITLE SHEET
T-2	EXISTING SITE CONDITIONS
T-3	SITE PLAN
T-4	FIRE ACCESS PLAN
T-5	SIGNING AND STRIPING PLAN
T-6	PROPOSED MAPPING INFORMATION
T-7	CONSTRUCTION DETAILS


**GENERAL NOTES**

- EROSION CONTROL PLAN WILL CONFORM TO APPLICABLE CITY, STATE AND FEDERAL STANDARDS.
- THE OWNER INTENDS TO FILE A FINAL MAP FOR A FIVE LOT SUBDIVISION FOR TOWN HOMES PURPOSES.

**ENGINEER'S STATEMENT**

THESE TENTATIVE MAPS HAVE BEEN PREPARED BY ME OR UNDER MY DIRECTION IN ACCORDANCE WITH STANDARD ENGINEERING PRACTICE.

*Tim Heffernan*  
TIMOTHY HEFFERNAN  
PROJECT MANAGER  
BKF ENGINEERS  
P.E. #67089  
6/1/2020  
DATE

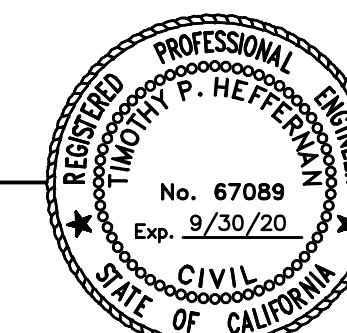

255 SHORELINE DR  
SUITE 200  
REDWOOD CITY, CA 94065  
650-482-6300  
650-482-6399 (FAX)

20 DEXTER AVENUE  
TENTATIVE MAP  
TITLE SHEET

CALIFORNIA  
SAN MATEO COUNTY  
REDWOOD CITY

Revisions	No.	Date	By	Check

Drawing Number: **T-1**





255 SHORELINE DR  
SUITE 200  
REDWOOD CITY, CA 94065  
650-482-6300  
650-482-6399 (FAX)



CALIFORNIA

**20 DEXTER AVENUE  
TENTATIVE MAP  
EXISTING SITE CONDITIONS**

SAN MATEO COUNTY  
REDWOOD CITY





DATE SIGNED 06/01/20

Revisions	No.	Date

Date: 6/1/20  
 Scale: 1"=10'  
 Design: MP  
 Drawn: MP  
 Approved: TH  
 Job No: 20190603


Drawing Number:  
**T-2**

DRAWING NAME: K:\2019\190603\_20\_Dexter\_Ave\_RWC\PLANNING\SHEETS\Tentative Map\T-2.dwg (Layout)  
PLOT TIME: 6-10-2020 10:49 AM  
PLOTTER: HP

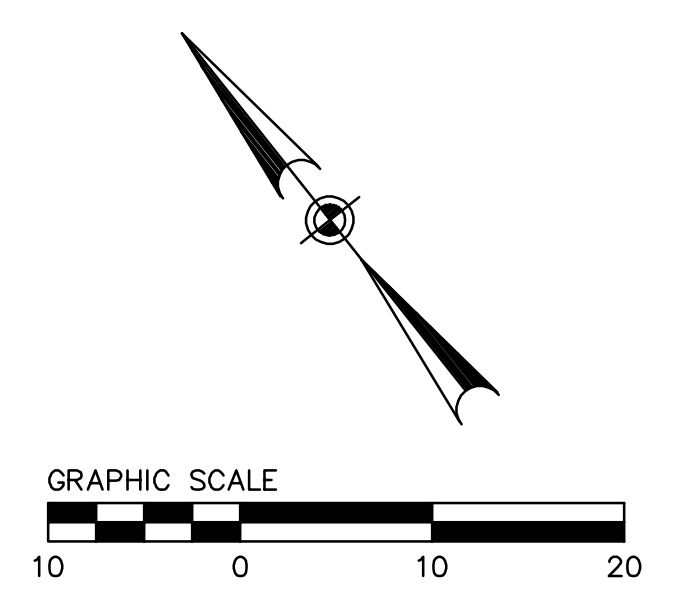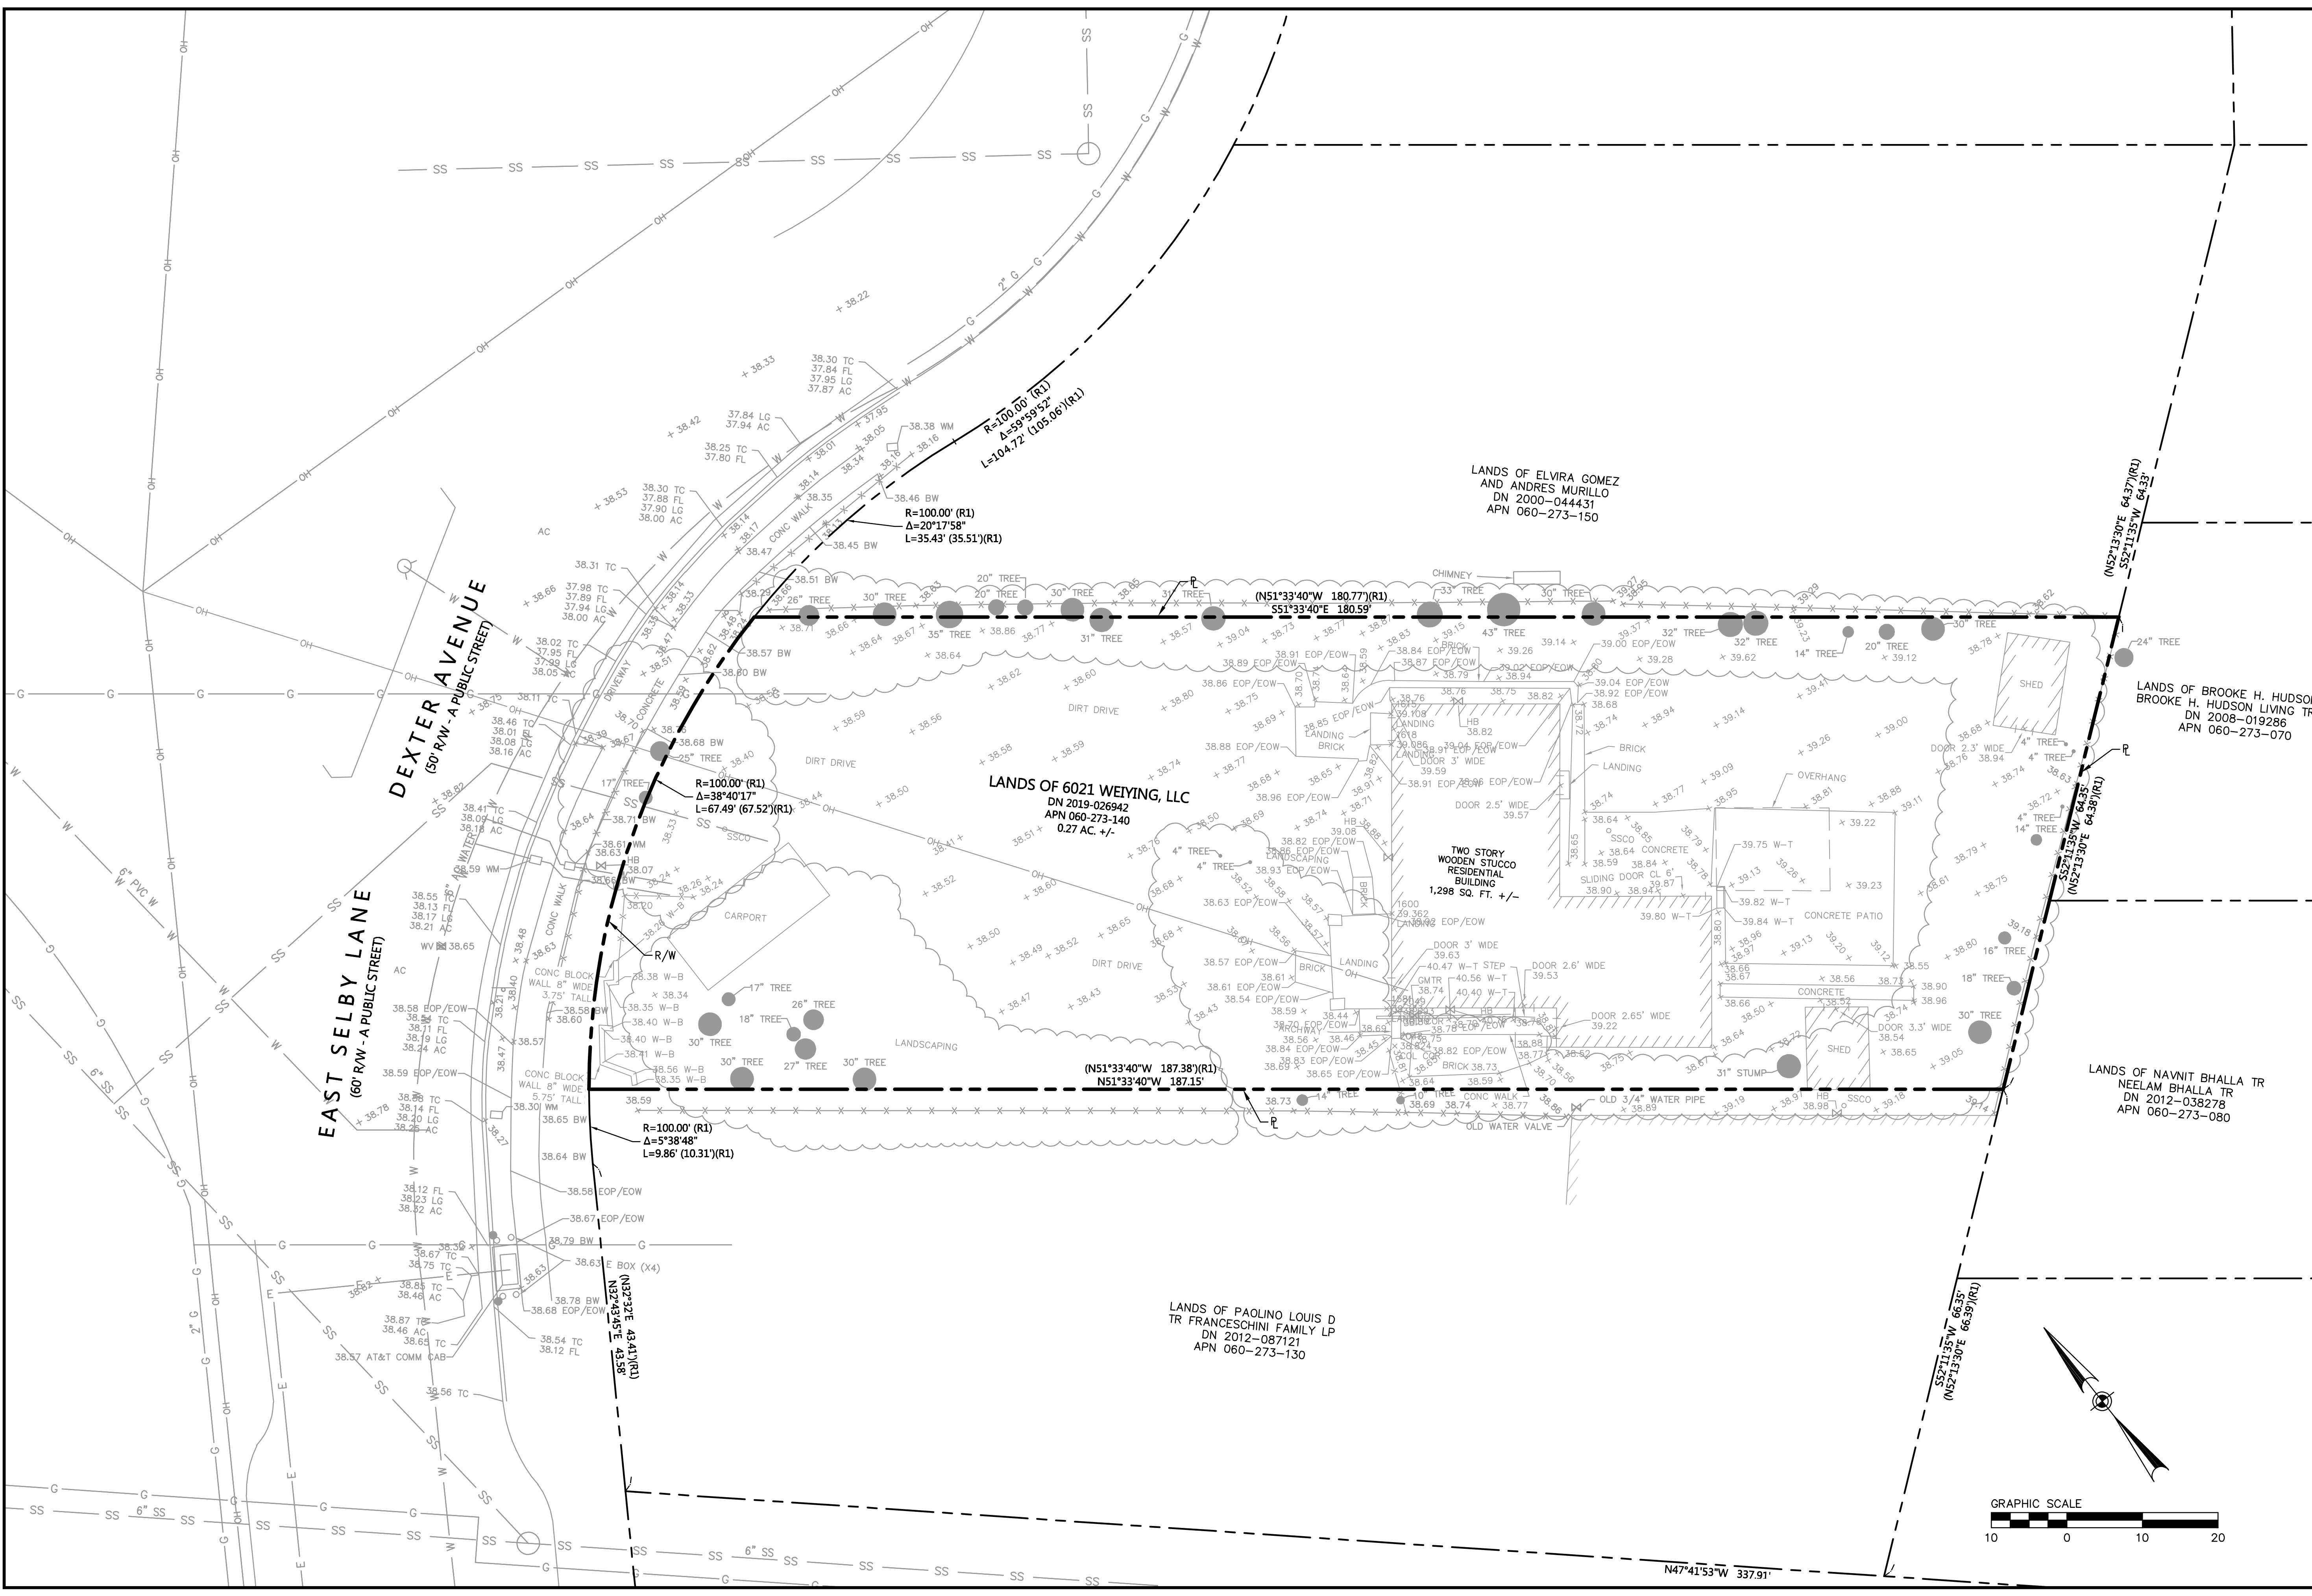

N47°41'53\"/>

DRAWING NAME: K:\2019\190603\_20\_Dexter\_Ave\_RWC\ENVP\PLANNING\SHEETS\Tentative Map\T-3.dwg (Layout)  
PLOT TIME: 5-10-2020 11:03 AM  
PLOTTER: B7: Pcm

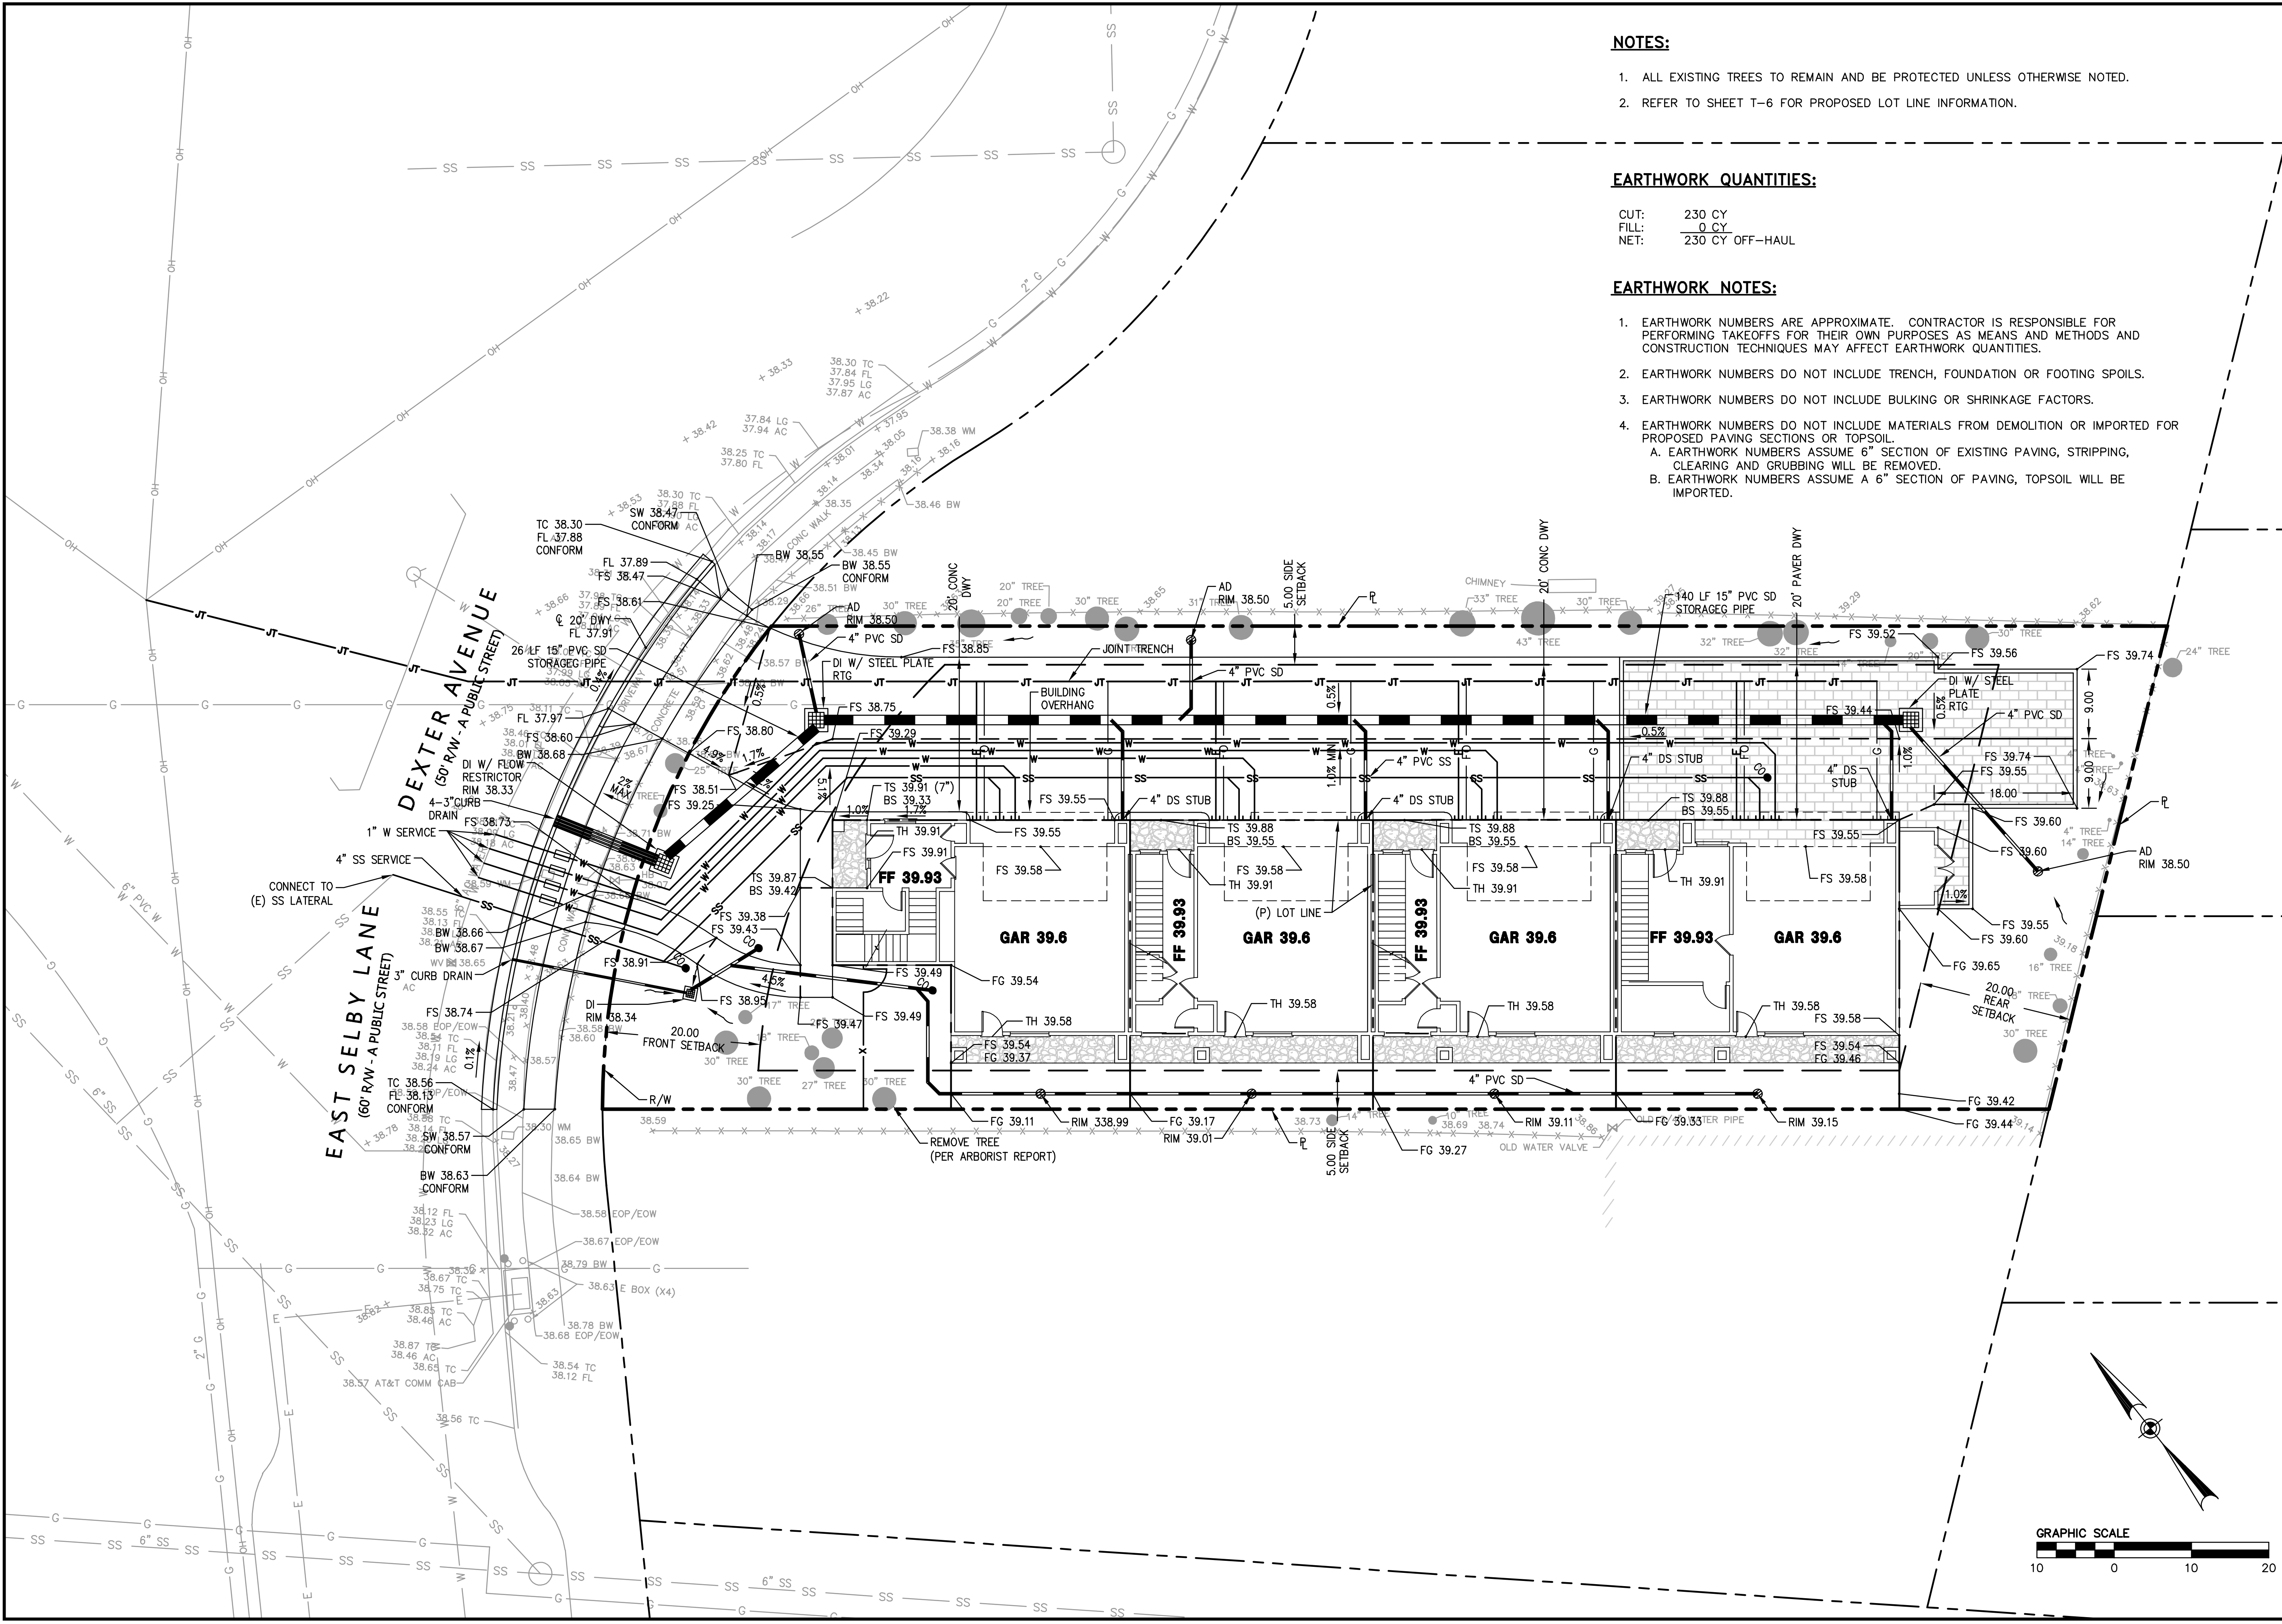

**NOTES:**

1. ALL EXISTING TREES TO REMAIN AND BE PROTECTED UNLESS OTHERWISE NOTED.
2. REFER TO SHEET T-6 FOR PROPOSED LOT LINE INFORMATION.

**EARTHWORK QUANTITIES:**

CUT: 230 CY  
 FILL: 0 CY  
 NET: 230 CY OFF-HAUL

**EARTHWORK NOTES:**

1. EARTHWORK NUMBERS ARE APPROXIMATE. CONTRACTOR IS RESPONSIBLE FOR PERFORMING TAKEOFFS FOR THEIR OWN PURPOSES AS MEANS AND METHODS AND CONSTRUCTION TECHNIQUES MAY AFFECT EARTHWORK QUANTITIES.
2. EARTHWORK NUMBERS DO NOT INCLUDE TRENCH, FOUNDATION OR FOOTING SPOILS.
3. EARTHWORK NUMBERS DO NOT INCLUDE BULKING OR SHRINKAGE FACTORS.
4. EARTHWORK NUMBERS DO NOT INCLUDE MATERIALS FROM DEMOLITION OR IMPORTED FOR PROPOSED PAVING SECTIONS OR TOPSOIL.
  - A. EARTHWORK NUMBERS ASSUME 6" SECTION OF EXISTING PAVING, STRIPPING, CLEARING AND GRUBBING WILL BE REMOVED.
  - B. EARTHWORK NUMBERS ASSUME A 6" SECTION OF PAVING, TOPSOIL WILL BE IMPORTED.

**20 DEXTER AVENUE  
 TENTATIVE MAP  
 SITE PLAN**

255 SHORELINE DR  
 SUITE 200  
 REDWOOD CITY, CA 94065  
 650-482-6300  
 650-482-6399 (FAX)



CALIFORNIA

SAN MATEO COUNTY


REDWOOD CITY




DATE SIGNED 06/01/20

Revisions	No.	Date	By	Appr.

Drawing Number:  
**T-3**

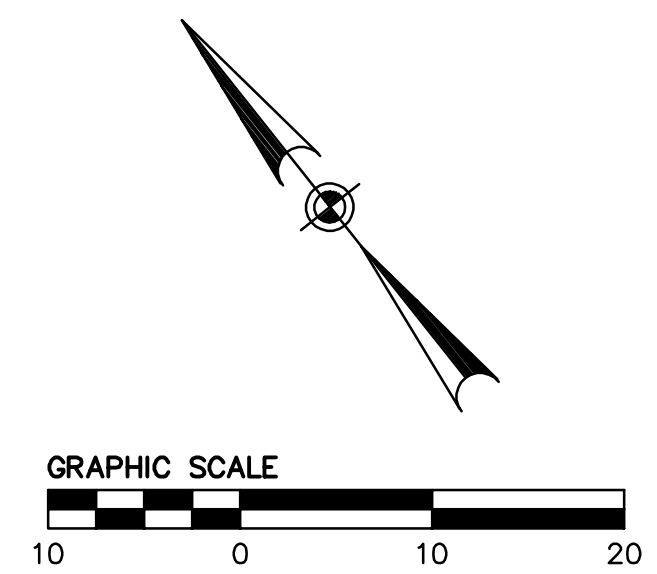


DRAWING NAME: K:\2019\190603\_20\_Dexter\_Ave\_RWC\ENR\PLANNING\SHEETS\Tentative Map\T-4.dwg (Layout)  
 PLOT TIME: 5-10-2020 10:49 AM

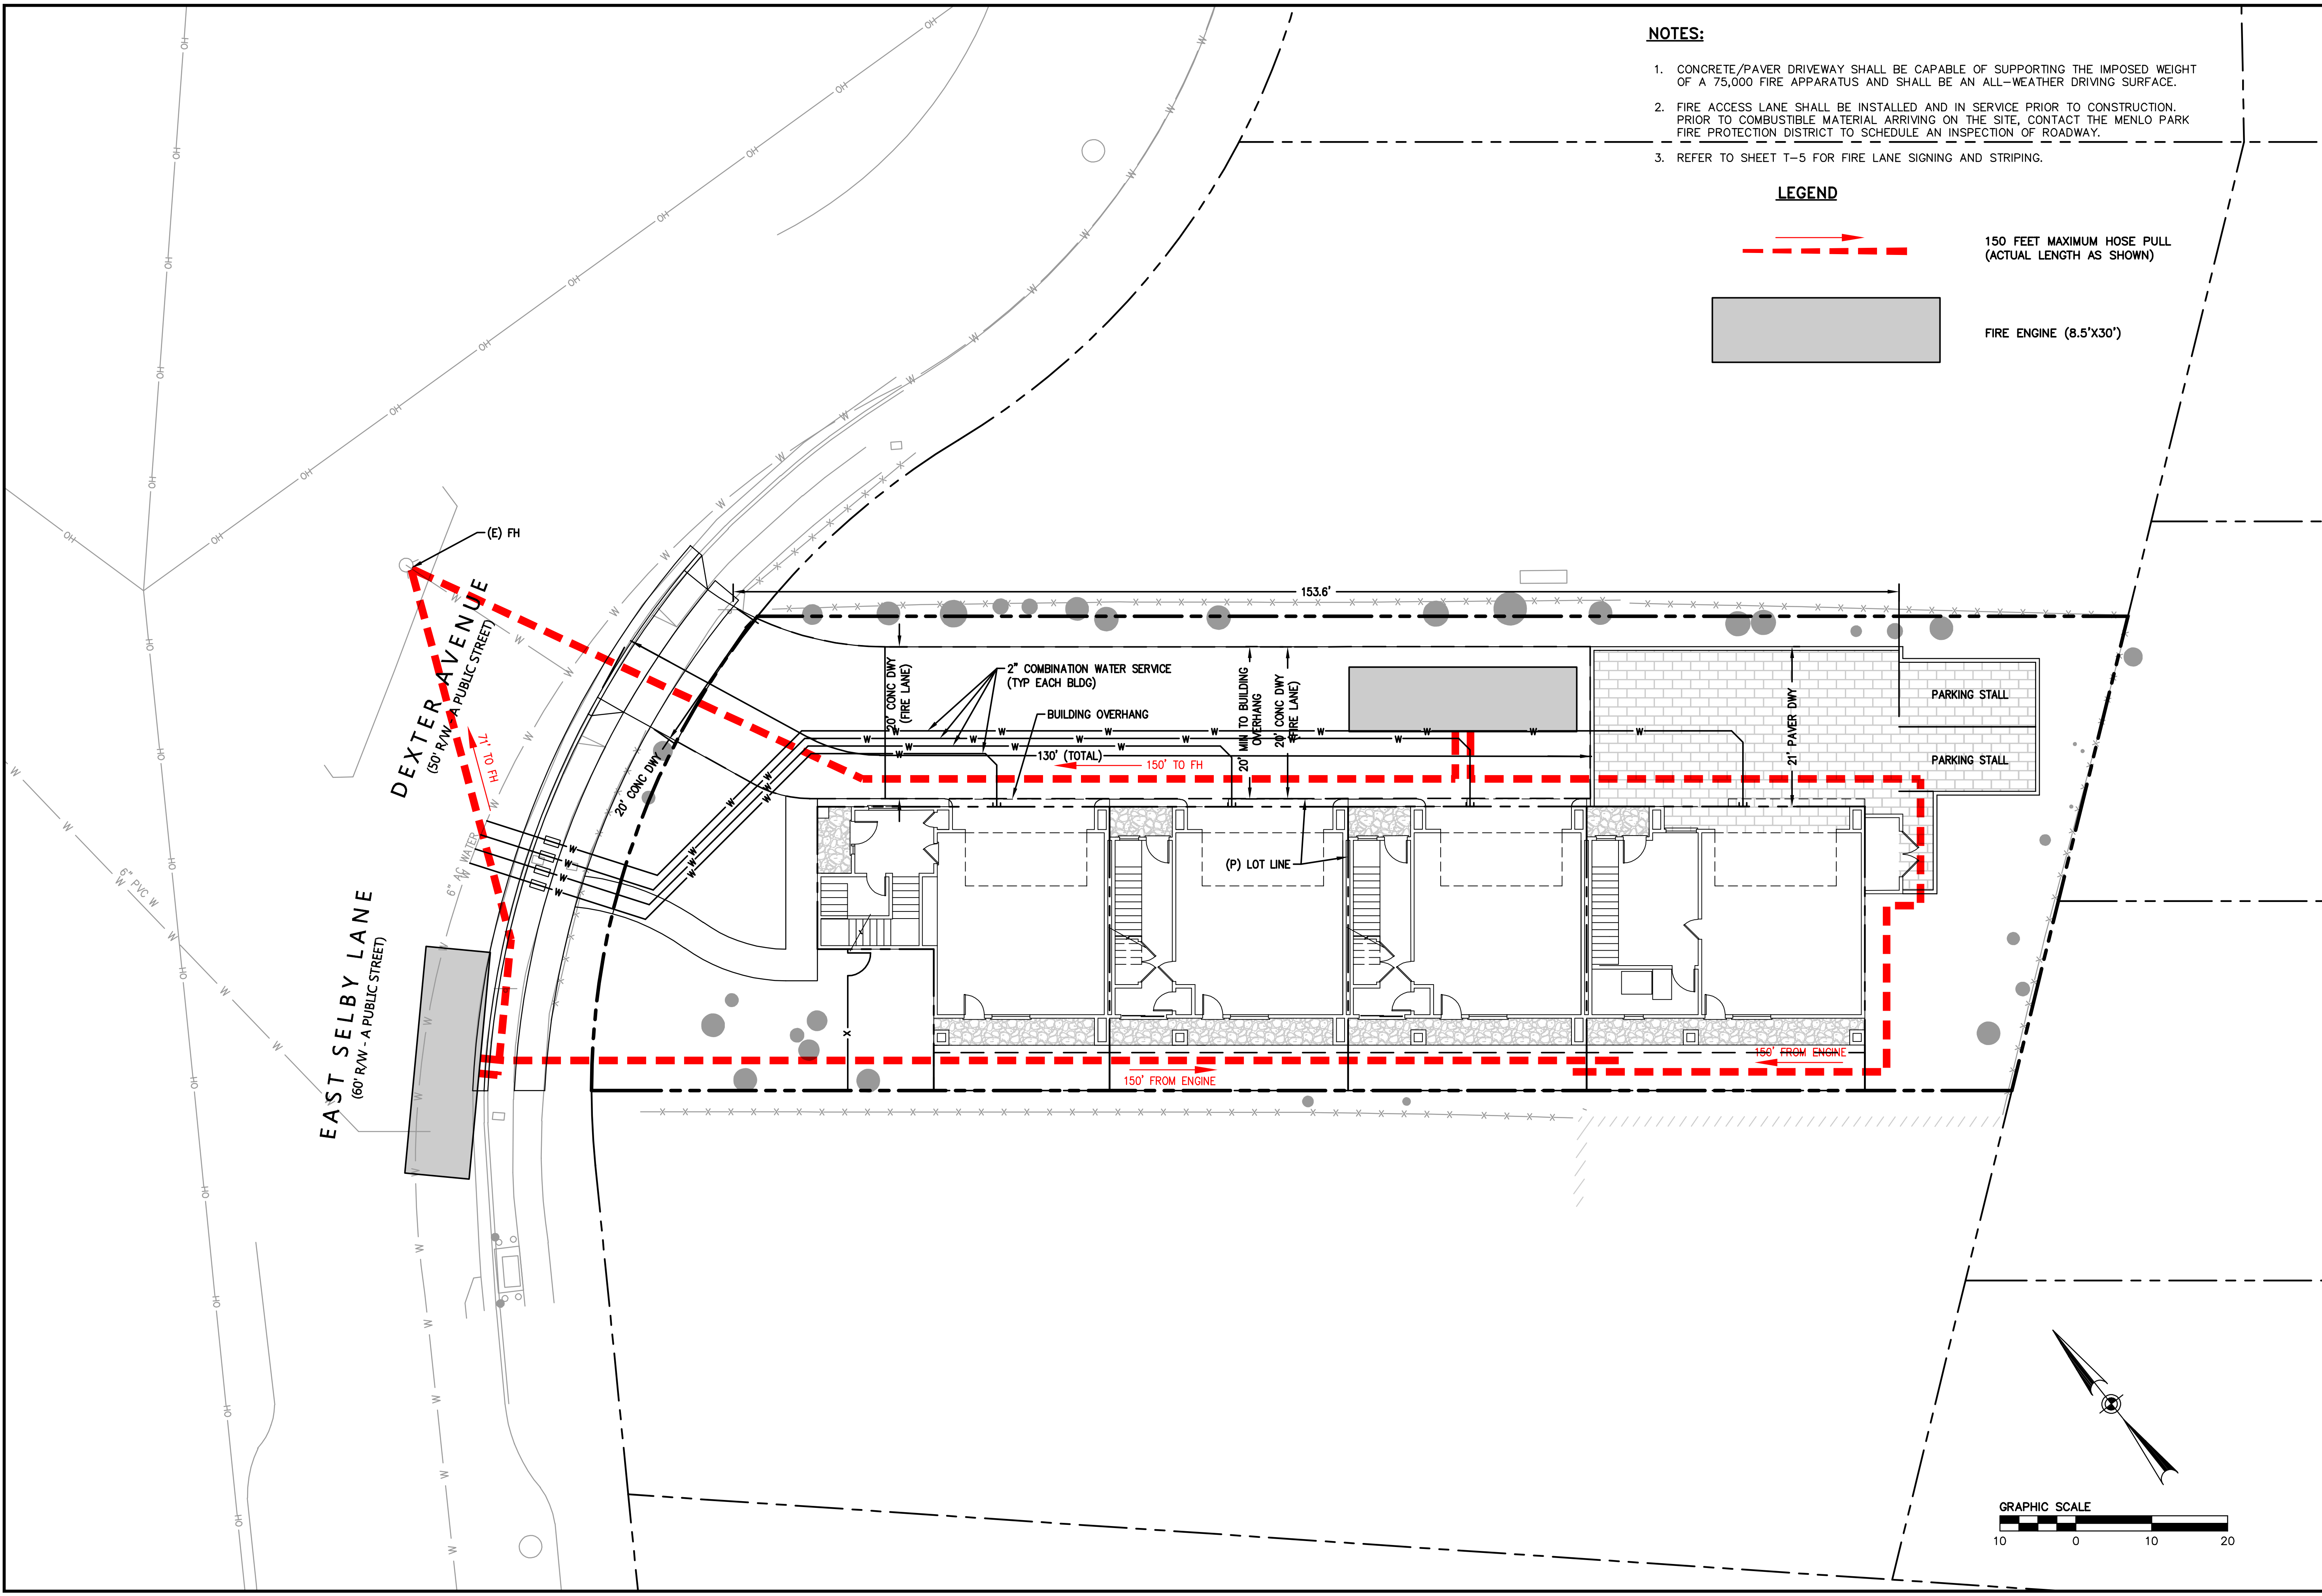

**NOTES:**

1. CONCRETE/PAVER DRIVEWAY SHALL BE CAPABLE OF SUPPORTING THE IMPOSED WEIGHT OF A 75,000 FIRE APPARATUS AND SHALL BE AN ALL-WEATHER DRIVING SURFACE.
2. FIRE ACCESS LANE SHALL BE INSTALLED AND IN SERVICE PRIOR TO CONSTRUCTION. PRIOR TO COMBUSTIBLE MATERIAL ARRIVING ON THE SITE, CONTACT THE MENLO PARK FIRE PROTECTION DISTRICT TO SCHEDULE AN INSPECTION OF ROADWAY.
3. REFER TO SHEET T-5 FOR FIRE LANE SIGNING AND STRIPING.

**LEGEND**

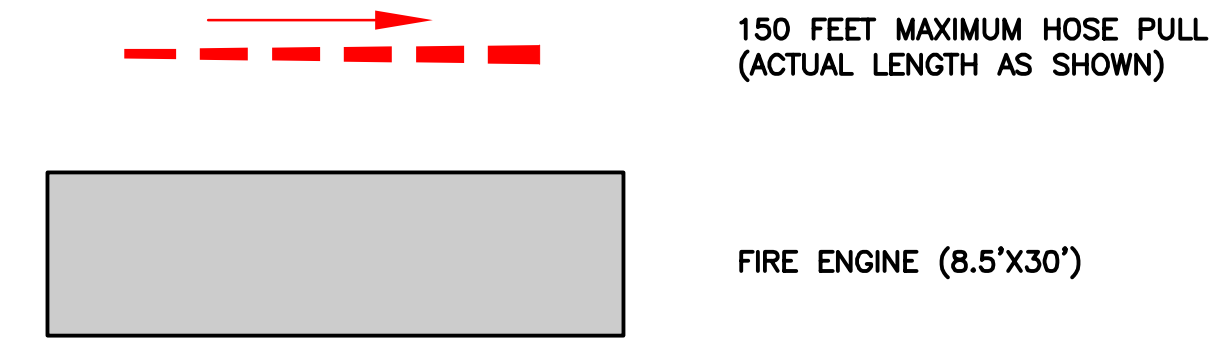

255 SHORELINE DR  
 SUITE 200  
 REDWOOD CITY, CA 94065  
 650-482-6300  
 650-482-6399 (FAX)



CALIFORNIA

**20 DEXTER AVENUE  
 TENTATIVE MAP  
 FIRE ACCESS PLAN**

REDWOOD CITY  
 SAN MATEO COUNTY



DATE SIGNED 06/01/20



Revisions	No.	Date	By

Drawing Number:  
**T-4**

DRAWING NAME: K:\2019\190603\_20\_Dexter\_Ave\_RWC\ENR\PLANNING\SHEETS\Tentative Map\T-5.dwg (Layout)  
 PLOT TIME: 6-10-2020 10:30 AM  
 PLOTTED BY: poon

**EAST SELBY LANE**  
 (60' R/W - A PUBLIC STREET)

**DEXTER AVENUE**  
 (60' R/W - A PUBLIC STREET)

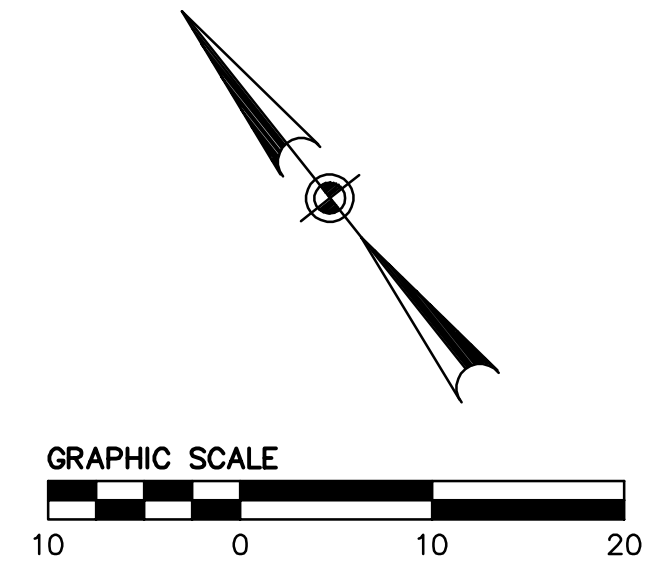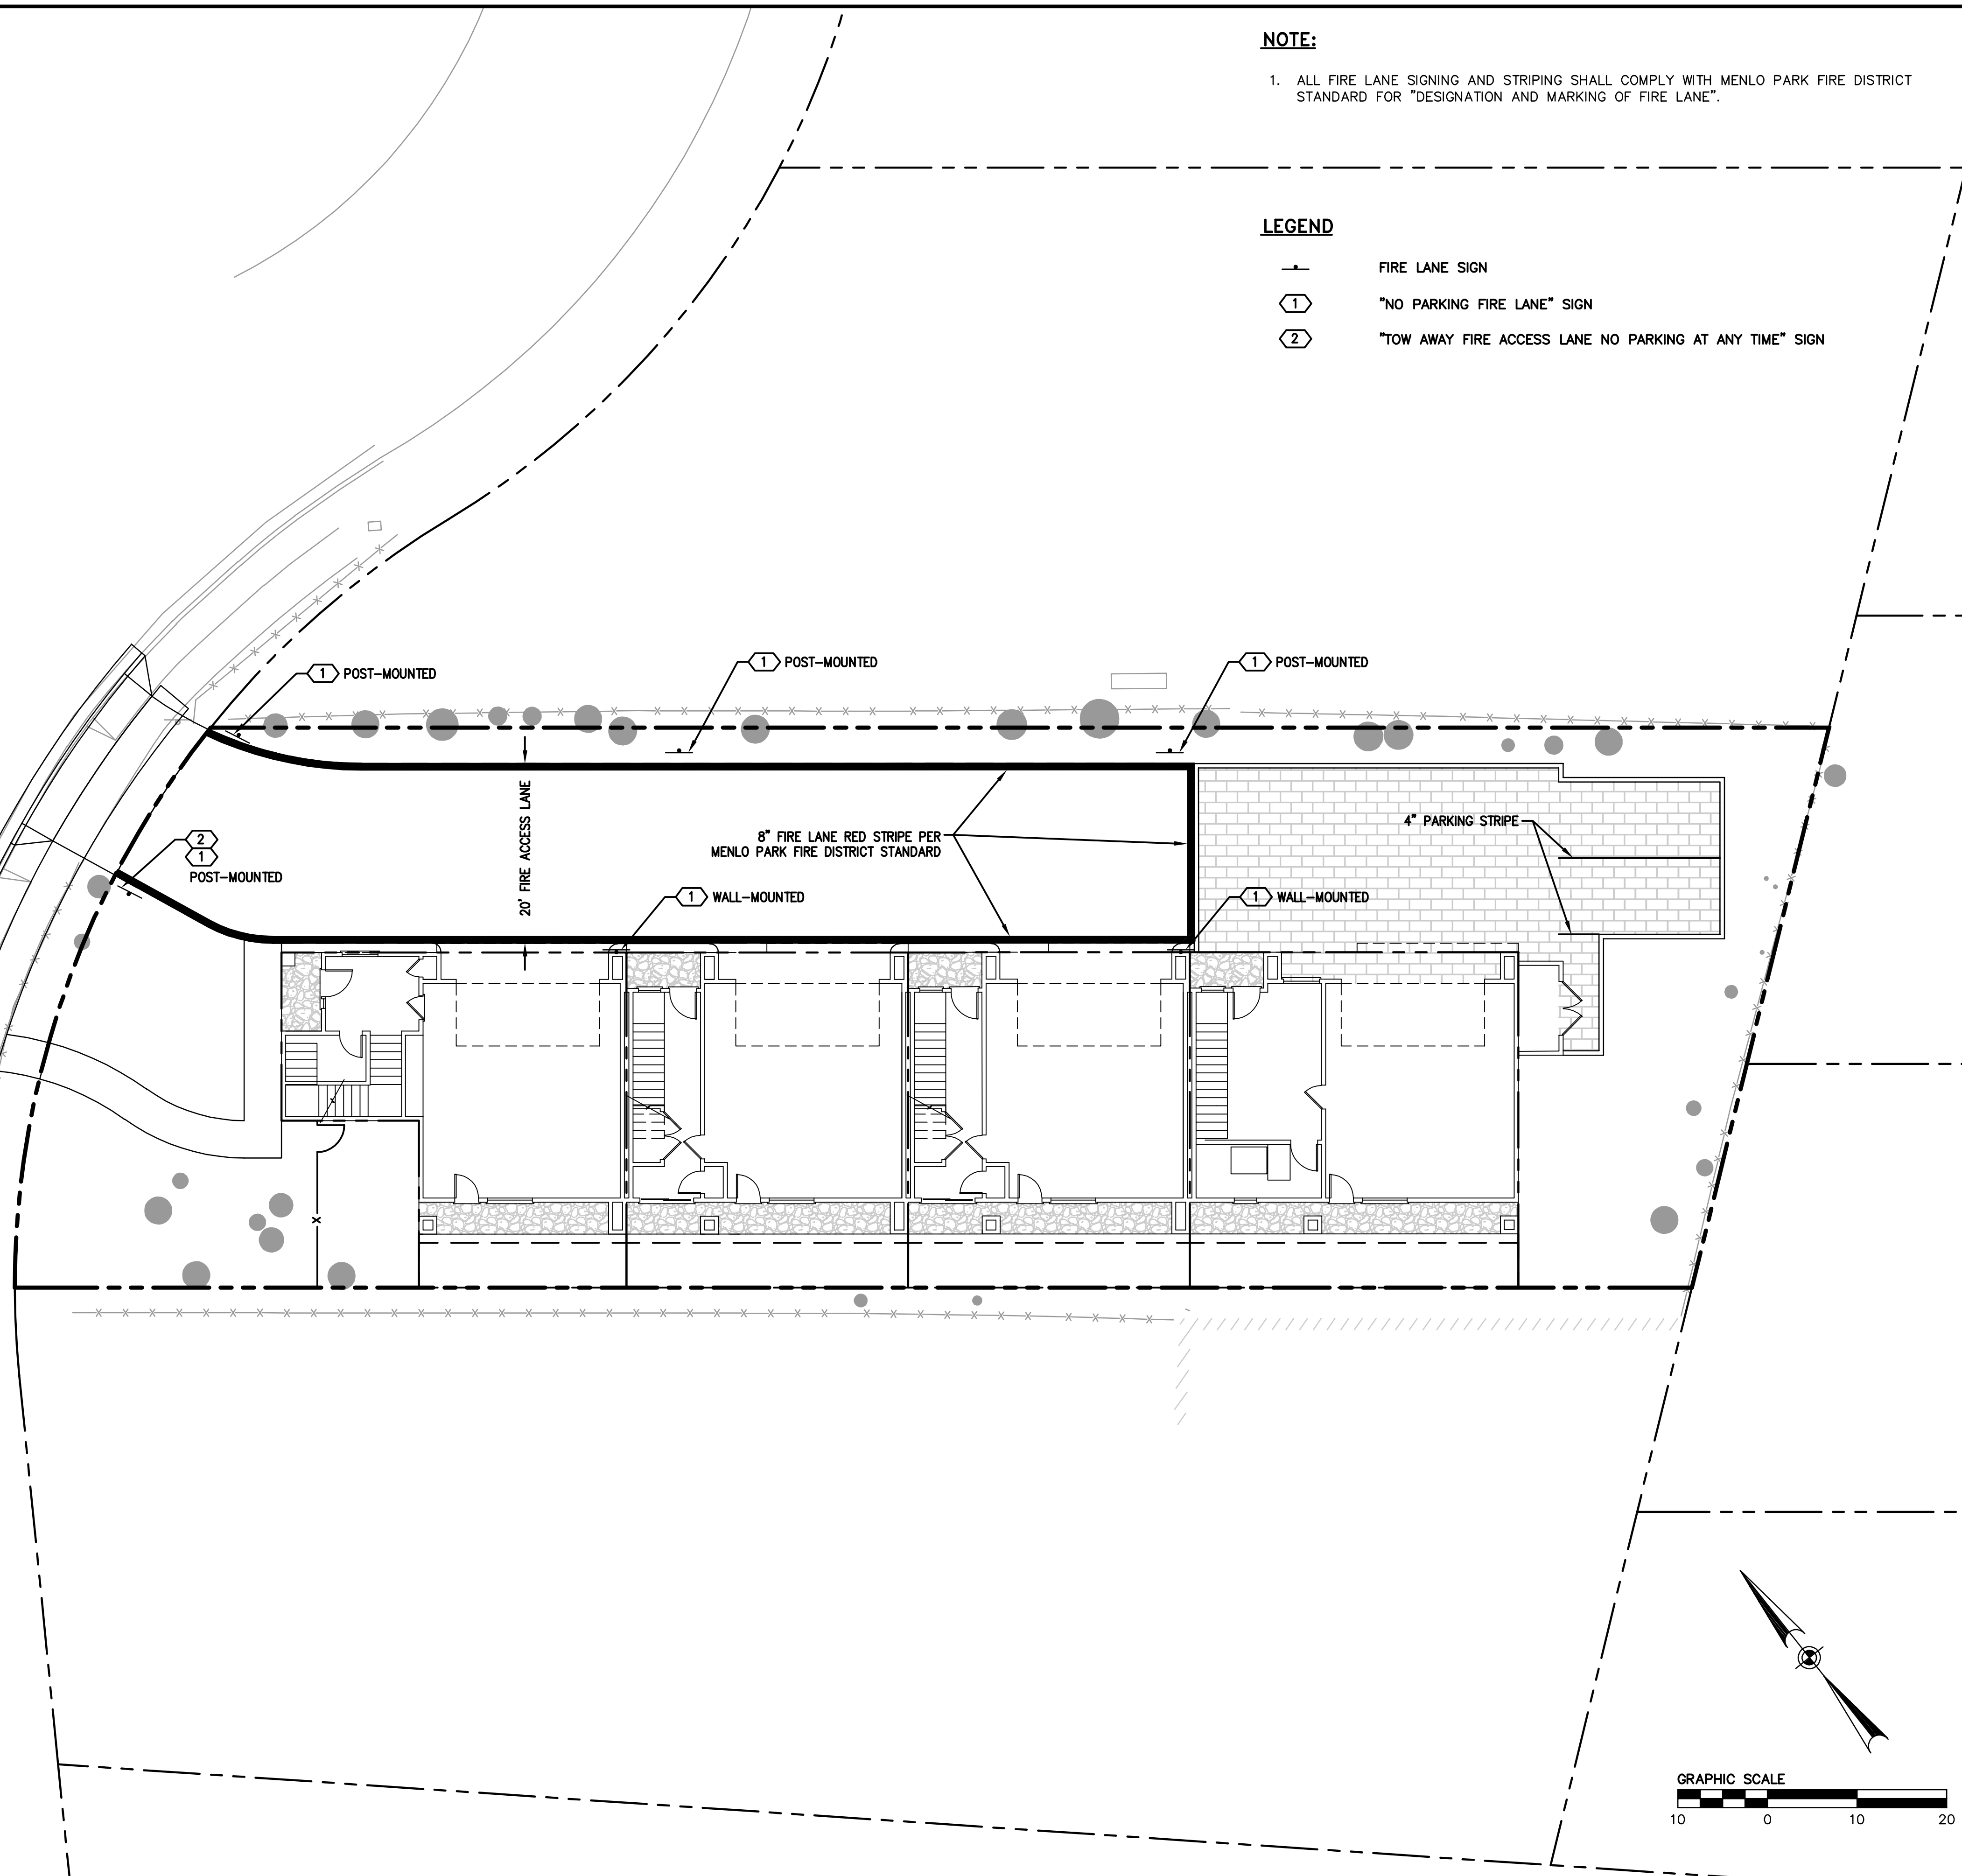

DATE SIGNED 06/01/20

Revisions	No.	Date	By	Appr.

Drawing Number:  
**T-5**

**20 DEXTER AVENUE**  
**TENTATIVE MAP**  
**SIGNING AND STRIPING PLAN**


REDWOOD CITY  
 SAN MATEO COUNTY  
 CALIFORNIA

**BKF**  
 ENGINEERS / SURVEYORS / PLANNERS


255 SHORELINE DR  
 SUITE 200  
 REDWOOD CITY, CA 94065  
 650-482-6300  
 650-482-6399 (FAX)



SAN MATEO COUNTY DEPARTMENT OF PUBLIC WORKS  
 DRAWN BY: N.M.  
 CHECK BY: J.A.L.  
 APPROVED BY: N.R.C.  
 SCALE: NONE  
 DATE: 6/95  
 REVISED: 4/97

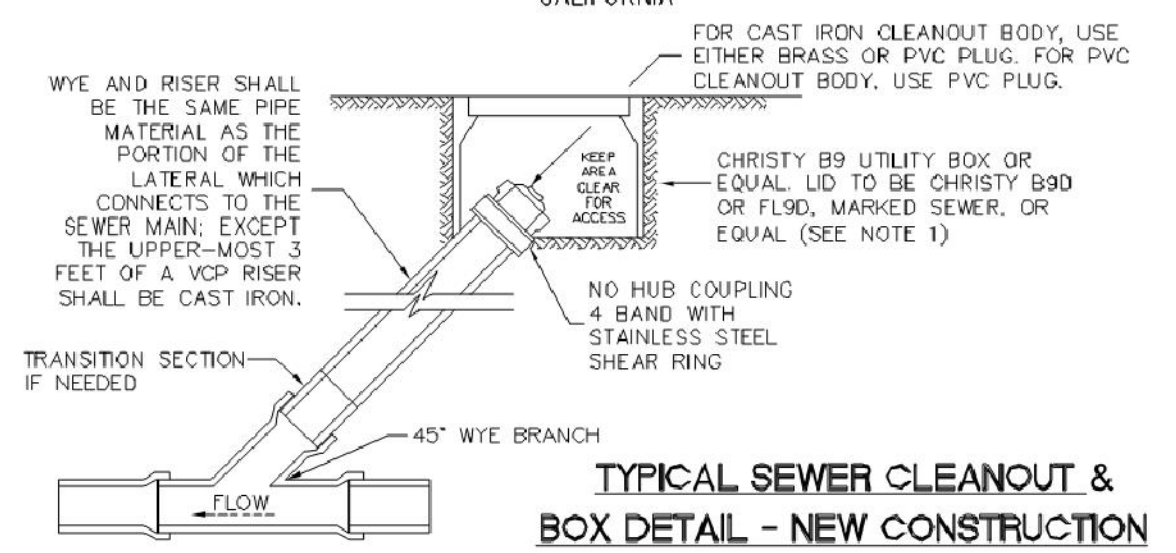

**TYPICAL SEWER CLEANOUT & BOX DETAIL - NEW CONSTRUCTION**

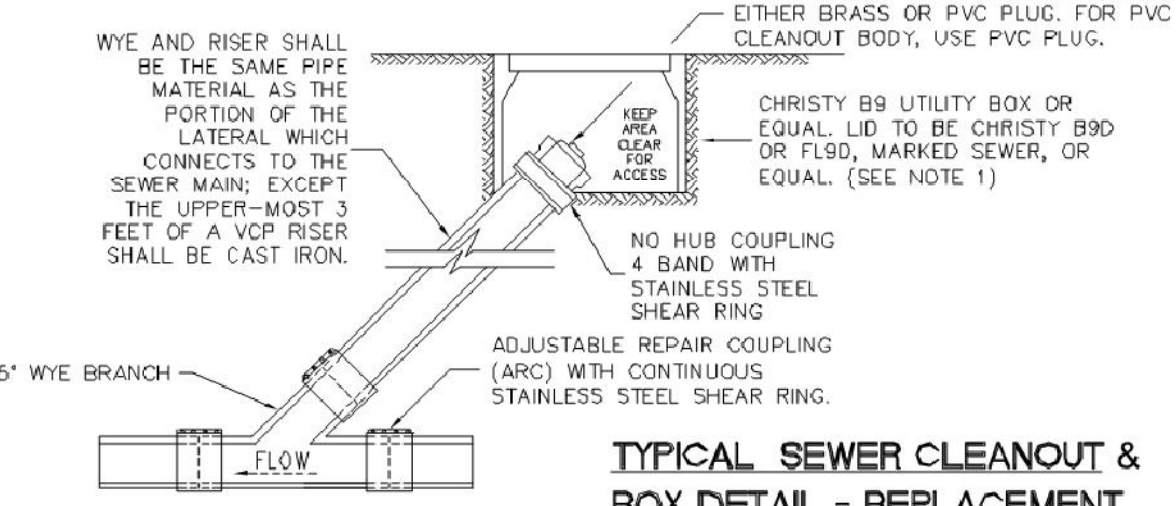


**TYPICAL SEWER CLEANOUT & BOX DETAIL - REPLACEMENT**


- NOTES:
1. WHEN BOX IS SUBJECT TO TRAFFIC LOADING, PROVIDE CAST IRON LID.
  2. BOX TO BE PLACED SUCH THAT CLEANOUT CAP CAN BE EASILY REMOVED, SEE ILLUSTRATION.
  3. PROPERTY OWNER IS RESPONSIBLE FOR MAINTAINING LATERAL FROM THE PROPERTY STRUCTURE TO DISTRICT MAIN. DISTRICT PROVIDES COURTESY SERVICE FROM DISTRICT STANDARD PROPERTY LINE CLEANOUT TO THE MAIN.
  4. SDR-26 WYE, RISER, CLEANOUT BODY AND CAP CAN BE USED ONLY WHEN LATERAL FROM PROPERTY LINE TO MAIN LINE IS REPLACED WITH SDR-26.
  5. WHEN ENTIRE LATERAL IS REPLACED, LATERAL FROM PROPERTY LINE CLEANOUT TO MAIN LINE SHALL HAVE A 14-1 UF QUACE MINIMUM SINGLE CONDUCTOR TRACER WIRE TAPED TO THE ENTIRE LENGTH OF THE PIPE.
- CONSTRUCTION OF A STANDARD CLEANOUT REQUIRES MULTIPLE INSPECTIONS BY DISTRICT PERSONNEL:
1. FIRST INSPECTION - TO INSPECT WYE AND RISER, WYE AND RISER MUST BE EXPOSED.
  2. SECOND INSPECTION - TO INSPECT PLACEMENT OF BOX, LID AND LOCATION OF CLEANOUT WITHIN BOX.

C-3

SAN MATEO COUNTY DEPARTMENT OF PUBLIC WORKS  
 DRAWN BY: D.P.  
 CHECK BY: J.A.L.  
 APPROVED BY: N.R.C.  
 SCALE: NONE  
 DATE: 6/95  
 REVISED: 4/97

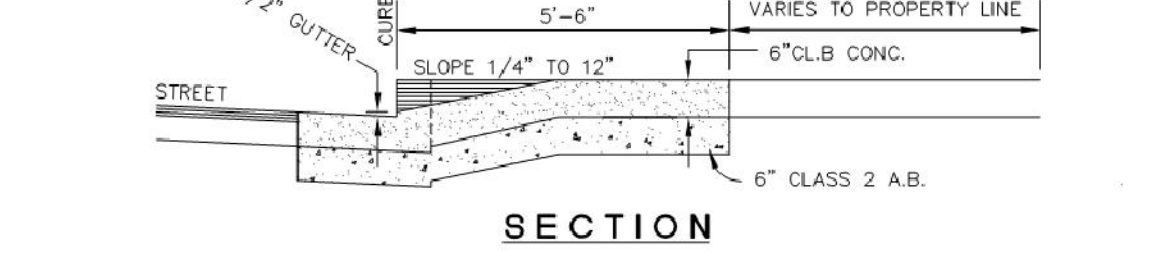

**SECTION**

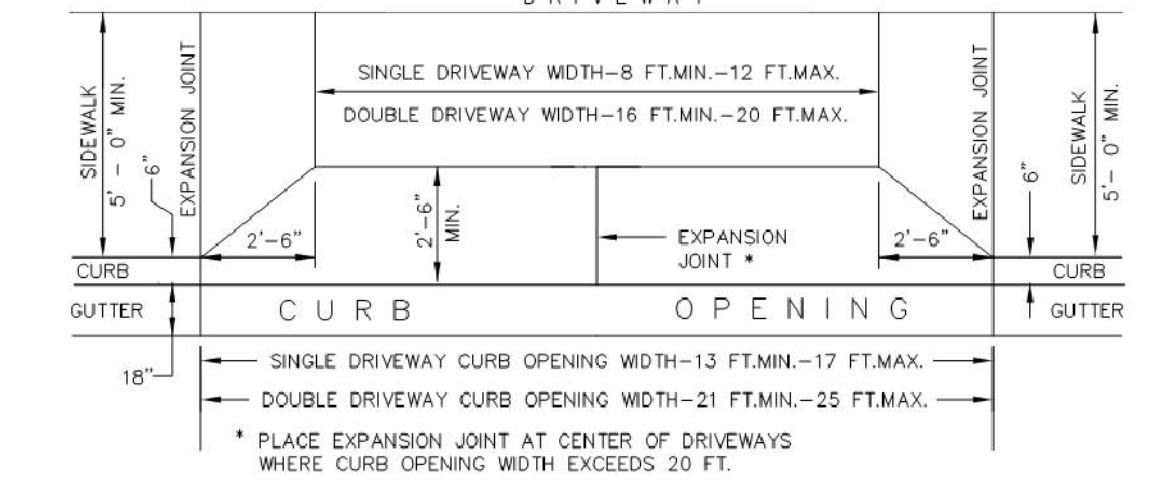

**PLAN**




**ELEVATION**

- NOTE:
1. WHERE POSSIBLE, 22 FT. DISTANCES OR MULTIPLES OF 22 FT. DISTANCES SHOULD BE OBTAINED BETWEEN CURB OPENINGS. CONSTRUCT MONOLITHIC CURB, GUTTER, DRIVEWAY AND APRON. WHERE DRIVEWAYS OF SEPARATE RESIDENTIAL DWELLINGS ARE CONSTRUCTED ADJACENT TO ONE ANOTHER, DOUBLE THE DIMENSIONS SHOWN ABOVE. USE NO. 4 REINFORCING BAR DOWELS AS SHOWN ON STANDARD CURB, GUTTER AND SIDEWALK DETAIL.


**STANDARD STRUCTURES  
 DRIVEWAY WIDTHS AND CURB OPENINGS  
 FOR  
 SINGLE FAMILY RESIDENTIAL DWELLINGS**

D-1

SAN MATEO COUNTY DEPARTMENT OF PUBLIC WORKS  
 DRAWN BY: M.L.  
 CHECK BY: J.A.L.  
 APPROVED BY: N.R.C.  
 SCALE: NONE  
 DATE: 6/95  
 REVISED: 4/97

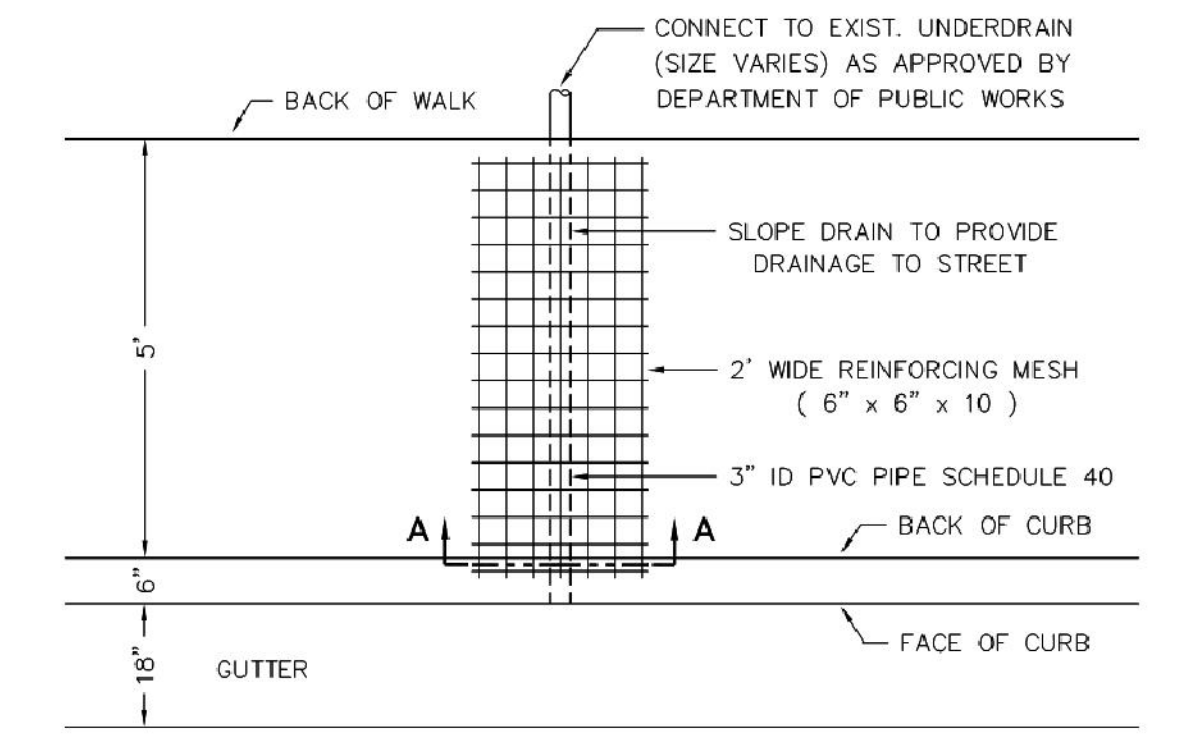

**PLAN**

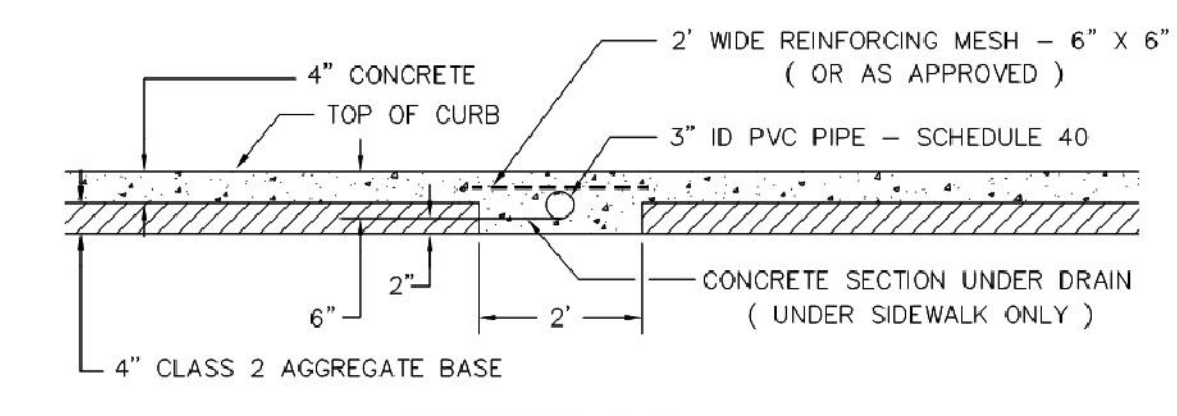


**SECTION A-A**

**DRAINAGE UNDER SIDEWALK**


D-6

SAN MATEO COUNTY DEPARTMENT OF PUBLIC WORKS  
 DRAWN BY: D.P.  
 CHECK BY: J.A.L.  
 APPROVED BY: N.R.C.  
 SCALE: NONE  
 DATE: 6/95  
 REVISED: 4/97

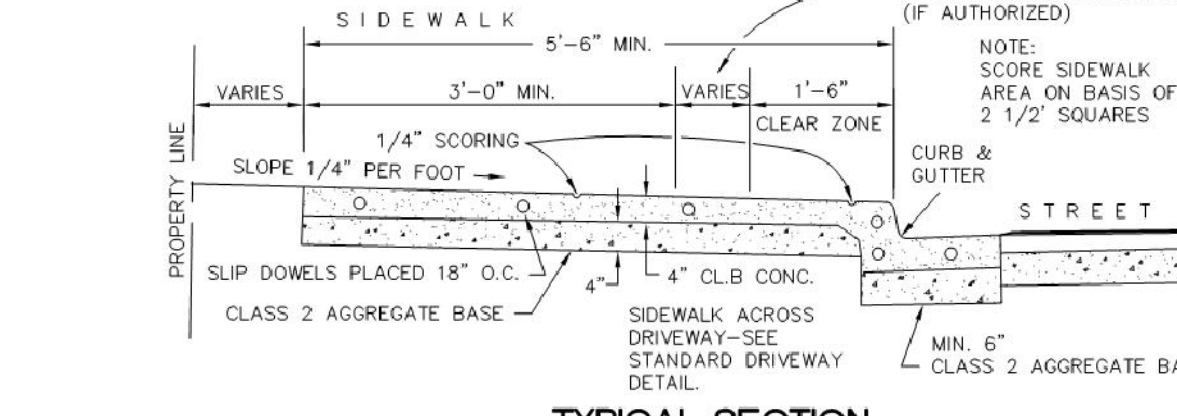

**TYPICAL SECTION  
 URBAN CURB, GUTTER AND SIDEWALK**


- NOTE: OBSTRUCTIONS SUCH AS POLES, HYDRANTS, STREET SIGNS, UTILITY BOXES, STREET LIGHTS, ETC. SHALL BE LOCATED BEHIND THE SIDEWALK, UNLESS OTHERWISE SPECIFICALLY AUTHORIZED BY THE DIRECTOR OF PUBLIC WORKS. A CLEAR ZONE ALONG THE CURB AND SIDEWALK 18 INCHES IN WIDTH (MEASURED FROM THE FACE OF THE CURB) SHALL BE KEPT CLEAR AND OPEN FROM ALL OBSTRUCTIONS. IN ADDITION, AN AREA 3 FEET IN WIDTH ALONG THE SIDEWALK, EXCLUSIVE OF THE CURB WIDTH, SHALL BE KEPT CLEAR AND OPEN FROM ALL OBSTRUCTIONS IN COMPLIANCE WITH THE STATE BUILDING CODE (PART 2, TITLE 24, C.A.C.).

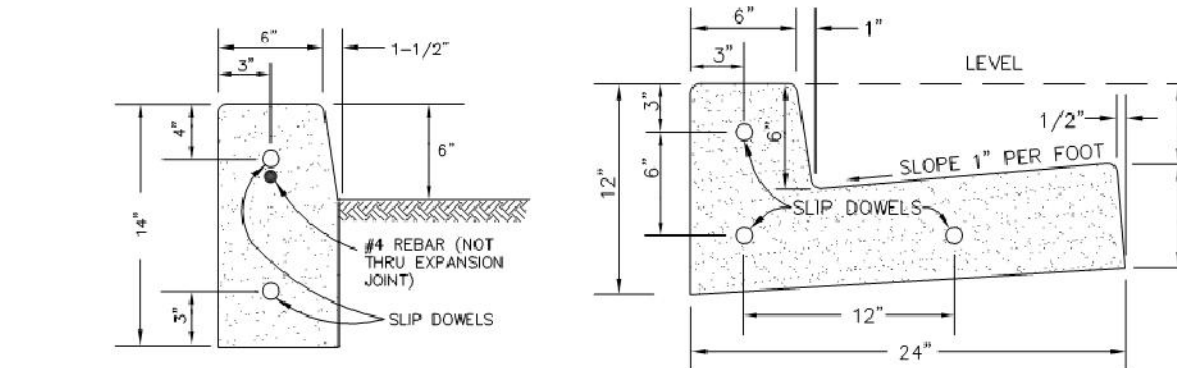

**TYPICAL SECTIONS**

- NOTES:
1. ALL CONCRETE TO BE CLASS B CONCRETE.
  2. MINIMUM SIDEWALK THICKNESS = 4 INCHES PCC.
  3. PLACE 1/2" DIAMETER X 18" LONG DOWELS AT EXPANSION JOINTS AS SHOWN.
  4. PLACE 1/2" THICK EXPANSION JOINTS FULL WIDTH 20' ON CENTER.
  5. CONSTRUCT MONOLITHIC CURB, GUTTER AND SIDEWALK UNLESS OTHERWISE SPECIFICALLY AUTHORIZED BY THE DIRECTOR OF PUBLIC WORKS.
  6. SUB-BASE MATERIALS WITHIN 30' OF SUBGRADE SHALL BE COMPACTED TO 95%.

D-3

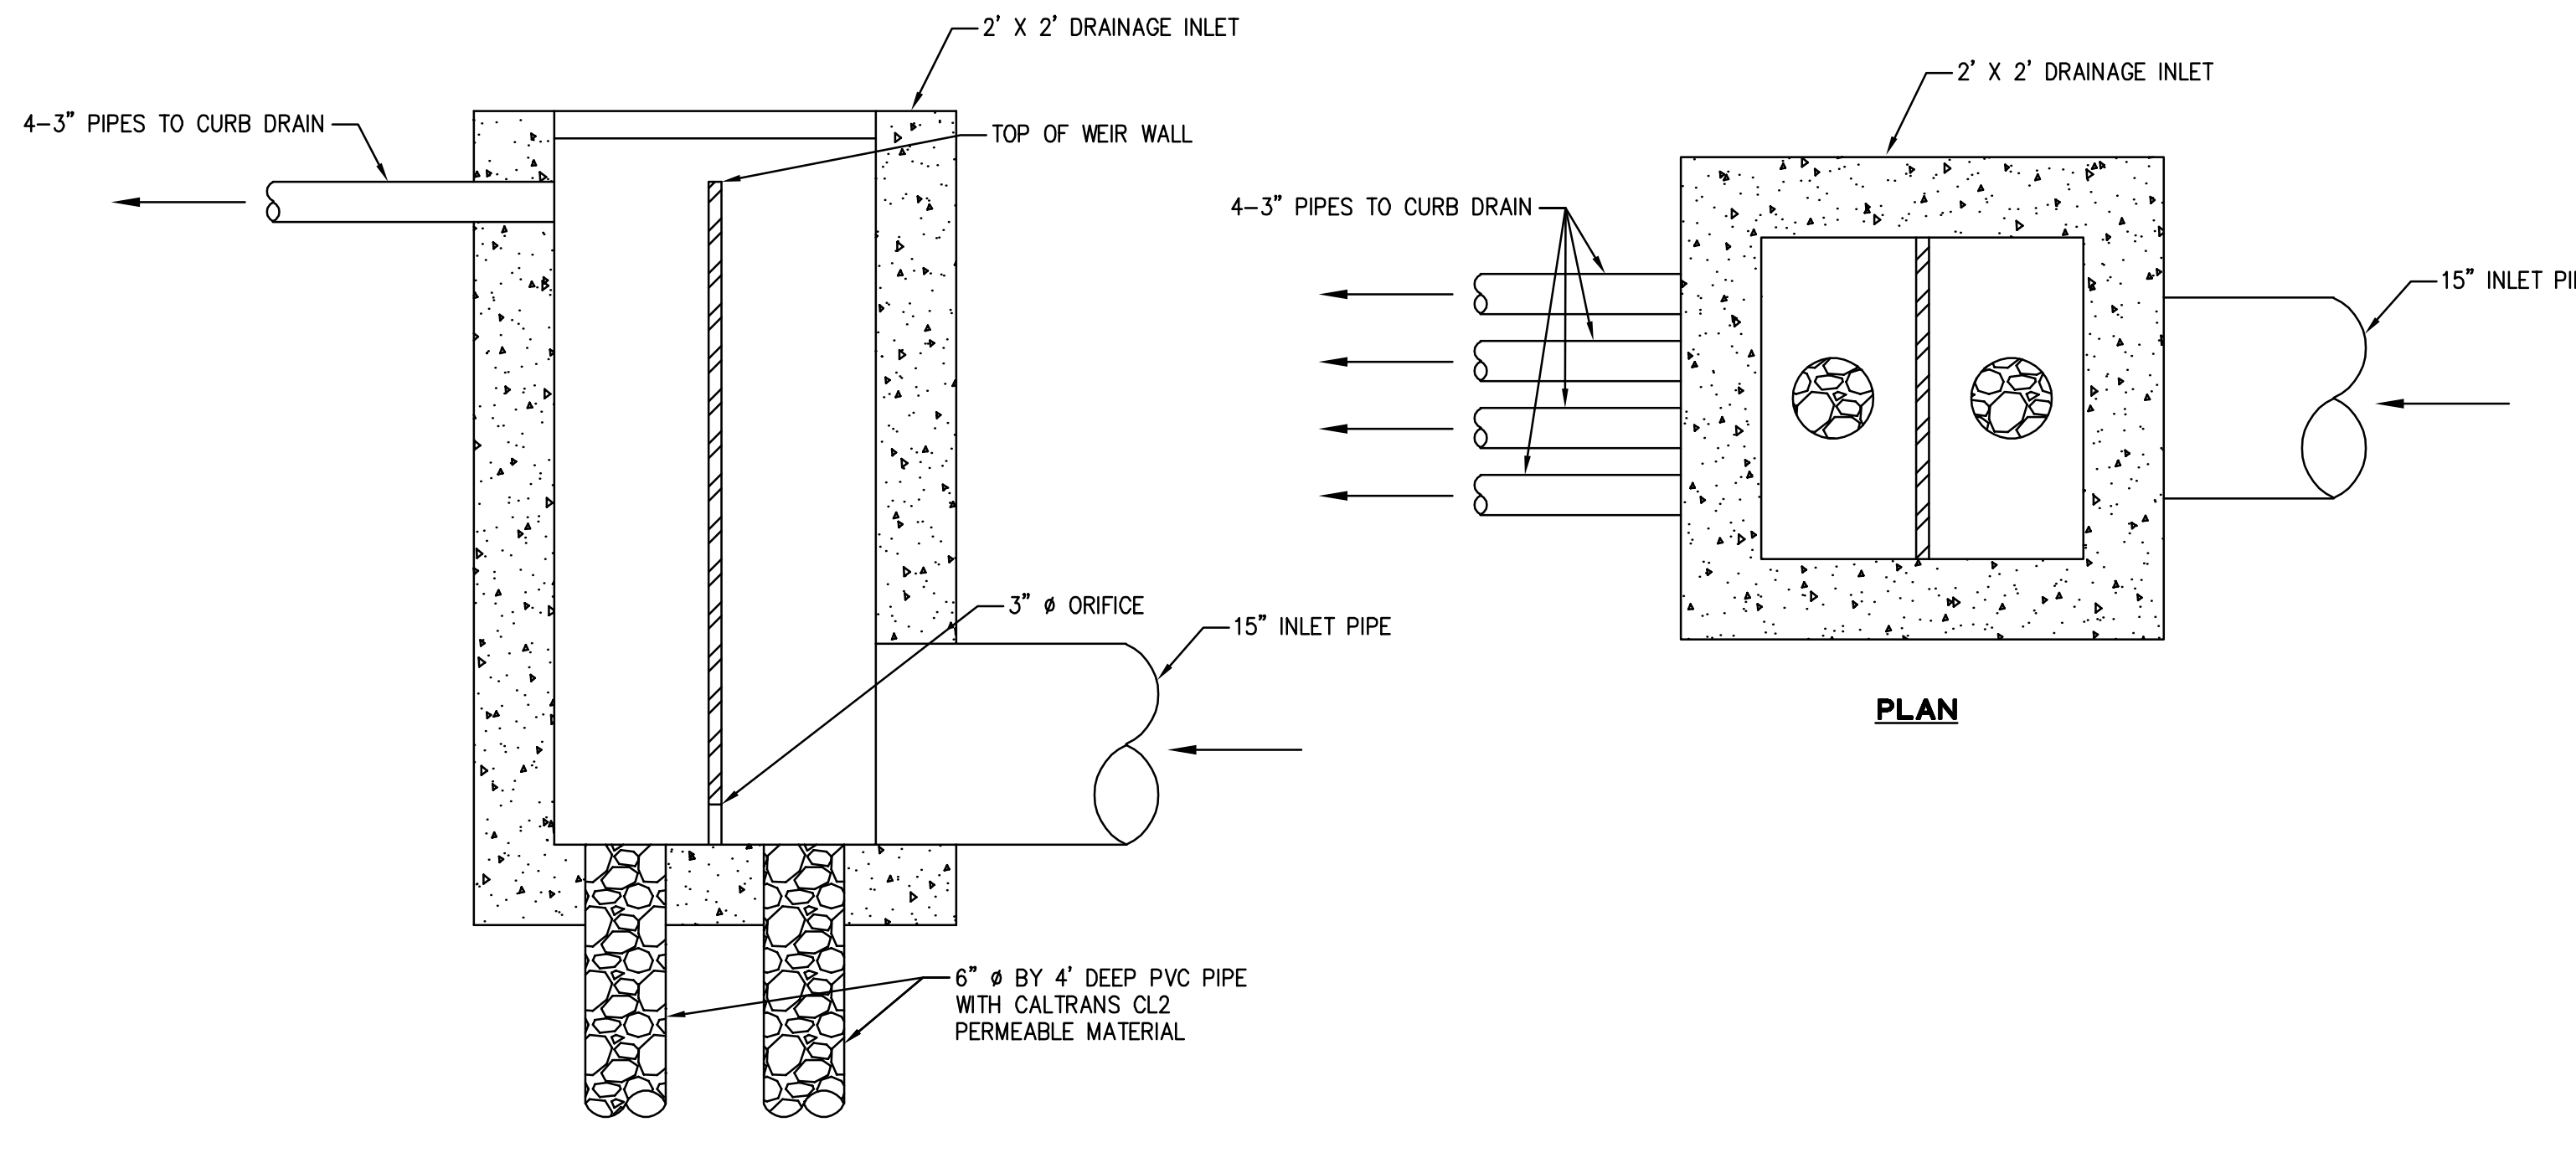

**SECTION**

**PLAN**

**DRAINAGE INLET W/ FLOW RESTRICTOR**

1

N.T.S.

DRAWING NAME: K:\2019\190603\_20\_Dexter\_Ave\_RWC\ENV\PLANNING\SHEETS\Tentative Map\T-7.dwg (Layout)  
 PLOT TIME: 6-10-2020 11:03 AM  
 PLOTTED BY: poon


255 SHORELINE DR  
 SUITE 200  
 REDWOOD CITY, CA 94065  
 650-482-6300  
 650-482-6399 (FAX)



CALIFORNIA

20 DEXTER AVENUE  
 TENTATIVE MAP  
 CONSTRUCTION DETAILS  
 SAN MATEO COUNTY

REDWOOD CITY

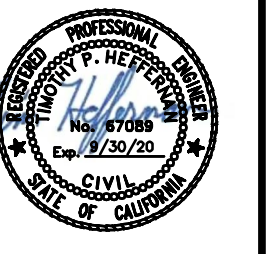

DATE SIGNED 06/01/20

Revisions	No.	Date	By

Drawing Number:  
**T-7**

**PROJECT TEAM**

OWNER:  
6021 WEIYING LLC  
20 DEXTER AVENUE  
REDWOOD CITY, CA 94063  
(510) 996-2941  
CONTACT: YING WANG

ARCHITECT: (PLAN PREPARER)  
DL ARCHITECTURE & PLANNING  
616 RAMONA ST. STE. 21  
PALO ALTO, CA 94301  
(650) 321-2808  
CONTACT: ERIC KENG

STRUCTURAL ENGINEER:  
TO BE DETERMINED

TITLE 24:  
TO BE DETERMINED

LANDSCAPE ARCHITECT  
GREGORY LEWIS LANDSCAPE ARCHITECT  
736 PARK WAY,  
SANTA CRUZ, CA 95065  
(831) 359-0960

LAND SURVEYOR/CIVIL ENGINEER:  
BKF ENGINEERS/SURVEYORS/ PLANNERS  
255 SHORELINE DR.  
REDWOOD CITY, CA 94065  
(650) 482-6300  
CONTACT: TIMOTHY HEFFERNAN

**SCOPE OF WORKS**

DEMOLISH EXISTING 1 STORY RESIDENCE AND DETACHED GARAGE, BASE ON R3/S5 ZONING PERMITTED USE OF MULTIPLE-FAMILY DWELLINGS AND S-5 WITH LOT WITH WIDER THAN 50FT. AND LOT SIZE LARGER THAN 5,000 SQ.FT. TO BUILD A NEW 4 DWELLING-UNIT BUILDING (LOT SIZE/2,500 SQ.FT. = ALLOWABLE UNIT: 11,744 /2,500 = 4.69) WITH 2 COVERED PARKING SPACES FOR EACH UNIT THROUGH AIR SPACE SUBDIVISION. THE NEW DEVELOPMENT WILL ALSO PROVIDE COMMON OPEN SPACE AND 2 PUBLIC PARKING SPACES FOR COMMUNITY ACTIVITIES.

**SHEET INDEX**

**ARCHITECTURAL:**


- T-1 TENTATIVE MAP TITLE SHEET
- T-2 EXISTING SITE CONDITION
- T-3 SITE PLAN
- T-4 FIRE ACCESS PLAN
- T-5 SIGNING AND STRIPING PLAN
- T-6 PROPOSED MAPPING INFORMATION
- T-7 CONSTRUCTION DETAILS
- SK-1 ARCHITECTURAL SITE PLAN, VICINITY MAP, PROJECT DATA
- SK-2 FLOOR PLANS
- SK-3 BUILDING ELEVATIONS
- L0 LANDSCAPE DOCUMENTATION
- L1 LANDSCAPE PLAN
- L2 IRRIGATION PLAN
- L3 LANDSCAPE DETAILS
- L4 LANDSCAPE SPECIFICATIONS

**PROJECT DATA**

A. APN: 060-273-140  
 B. ZONING: R-3/S-5  
 C. OCCUPANCY: R-2  
 D. SITE AREA: 11,744 SQ.FT. (0.27 AC)  
 E. SITE DENSITY: 2,500/DU = 4 DU/LOT  
 F. TOTAL STORIES: 3  
 G. PARKING SPACES: 8 COVERED, (2 GUEST PARKING)  
 H. FIRE SPRINKLER: YES  
 J. SETBACK: SEE SITE PLAN  
 K. PRIVATE YARD: 300-600 SQ.FT./DU  
 L. PUBLIC OPEN SPACE: 1,000 SQ.FT.  
 M. BUILDING PAD: AVERAGE 1,000 SQ.FT.  
 N. DRIVEWAY: 20 FT (24.0 FT IN FRONT OF GARAGE)  
 O. FLOOR AREA

	1st FLOOR	2nd FLOOR	3rd FLOOR	TOTAL	GARAGE
UNIT "A"	245 SQ.FT.	956 SQ.FT.	946 SQ.FT.	2,147 SQ.FT.	587 SQ.FT.
UNIT "B"	225 SQ.FT.	1,003 SQ.FT.	984 SQ.FT.	2,212 SQ.FT.	556 SQ.FT.
UNIT "C"	225 SQ.FT.	1,003 SQ.FT.	984 SQ.FT.	2,212 SQ.FT.	556 SQ.FT.
UNIT "D"	333 SQ.FT.	1,222 SQ.FT.	1,107 SQ.FT.	2,662 SQ.FT.	570 SQ.FT.

FAR: = 11,502 / 11,744 = 0.98  
 LOT COVERAGE: = 4,112 / 11,744 = 35.0%  
 TOTAL LIVING SPACE: 9,233 SQ.FT.

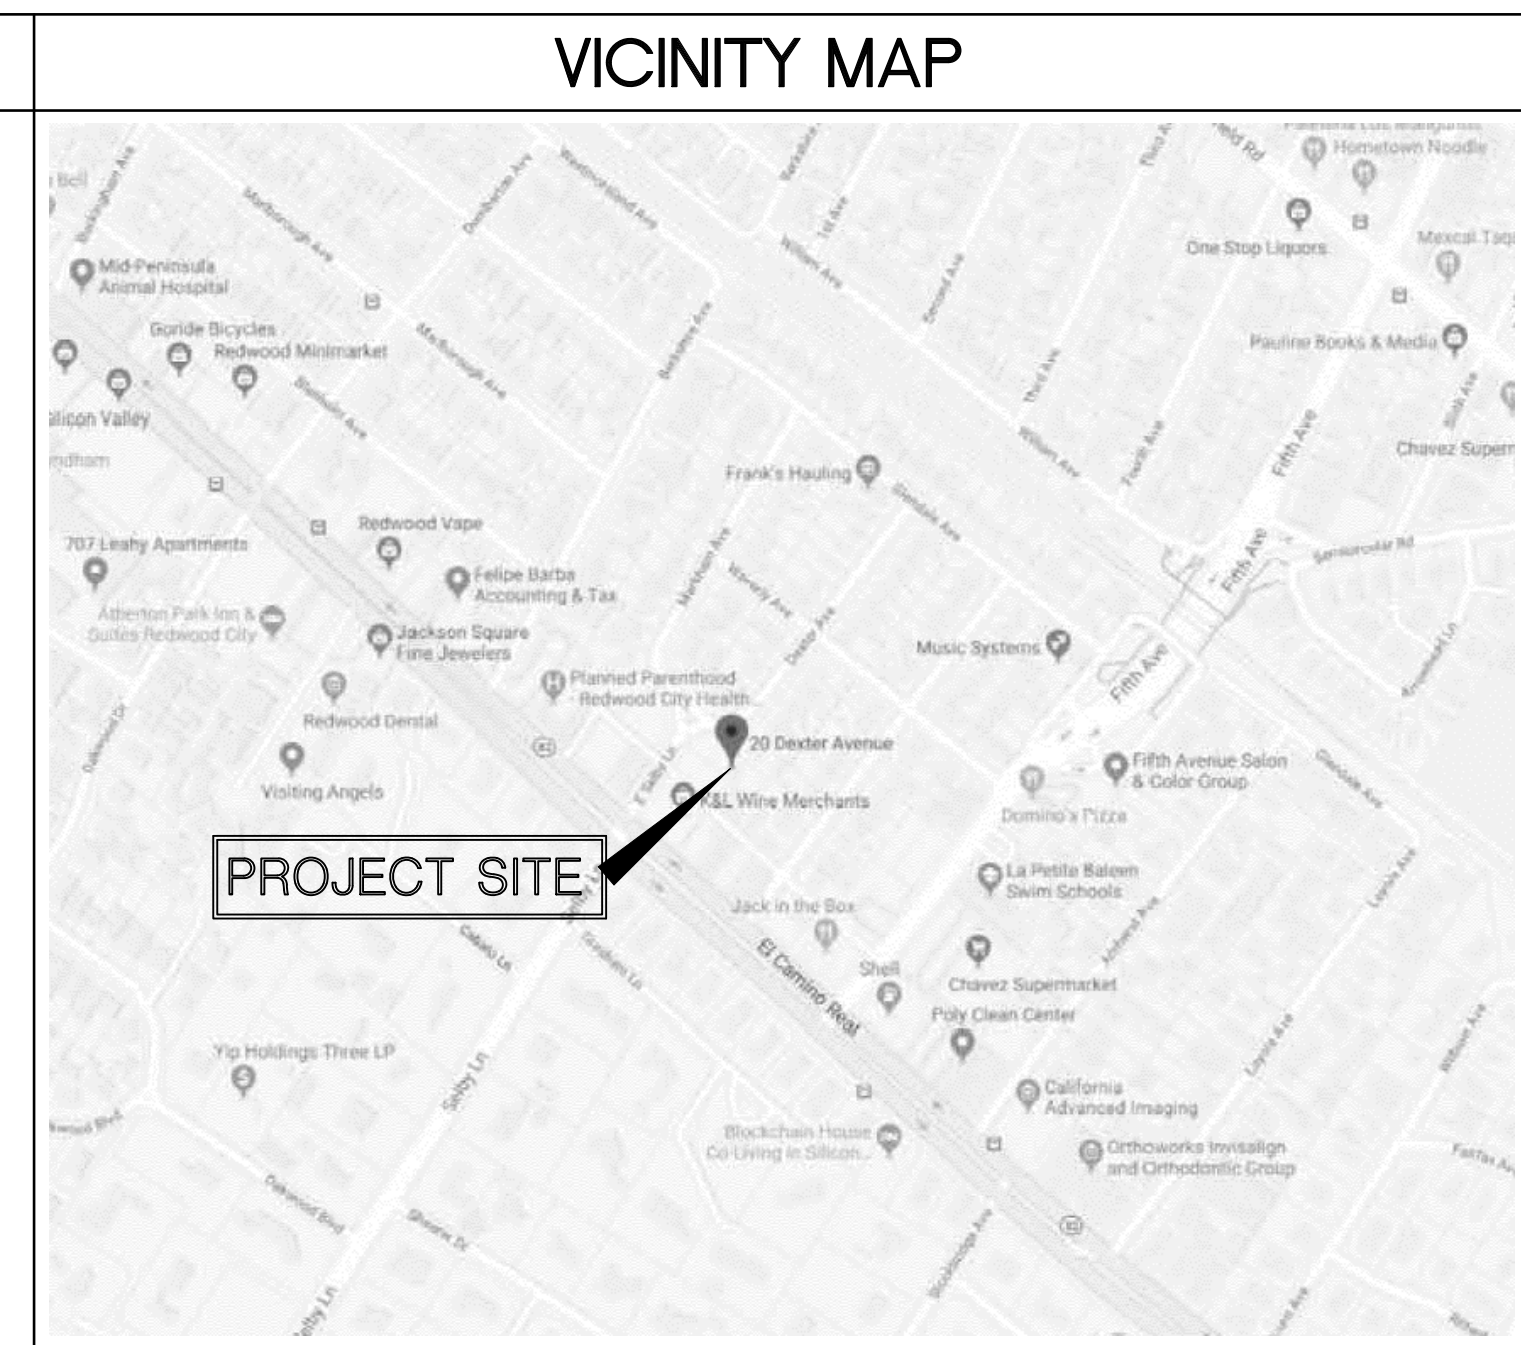

**DL Architecture & Planning**

616 RAMONA ST. STE 21  
PALO ALTO, CA 94301  
(650) 321-2808

This document constitutes original copyrighted material produced as an instrument of service by Architect Eric Keng. These documents shall not be utilized and/or duplicated without the permission of the Architect in writing. The design remains the sole property of Eric Keng and/or DL Architecture & Planning.

Seals:

Client:  
**DEXTER VILLA**

20 DEXTER AVENUE  
REDWOOD CITY, CA


**FIRE DEPARTMENT NOTES:**

ALL CURBING LOCATED WITHIN THE COMPLEX THAT HAS NOT BEEN ASSIGNED AS ONSITE PARKING SHALL BE DESIGNATED AS 'NO PARKING FIRE LANE'. ALL FIRE LANES TO COMPLY WITH MPFD STANDARD FOR 'DESIGNATION AND MARKING OF FIRE LANE' PROVIDE A COMPLETE NO PARKING-FIRE LANE STRIPPING PLAN WITH NO PARKING SIGNAGE IN ACCORDANCE TO MPFD STANDARD ON SUBSEQUENT SUBMITTAL

FIRE APPARATUS ROADWAYS, INCLUDING PUBLIC OR PRIVATE STREETS OR ROADS USED FOR VEHICLE ACCESS SHALL BE INSTALLED AND IN SERVICE PRIOR TO CONSTRUCTION. FIRE PROTECTION WATER SERVING ALL HYDRANTS SHALL BE PROVIDED AS SOON AS COMBUSTIBLE MATERIAL ARRIVES ON THE SITE.

PRIOR TO COMBUSTIBLE MATERIAL ARRIVING ON THE SITE, CONTACT THE MENLO PARK FIRE PROTECTION DISTRICT TO SCHEDULE AN INSPECTION OF ROADWAYS AND FIRE HYDRANTS. CFC 2019

ALL EMERGENCY VEHICLE ACCESS (EVA) ROADWAYS SHALL BE 'PUBLICLY RECORDED WITH THE COUNTY OF SAN MATEO ACCESSORS OFFICE'

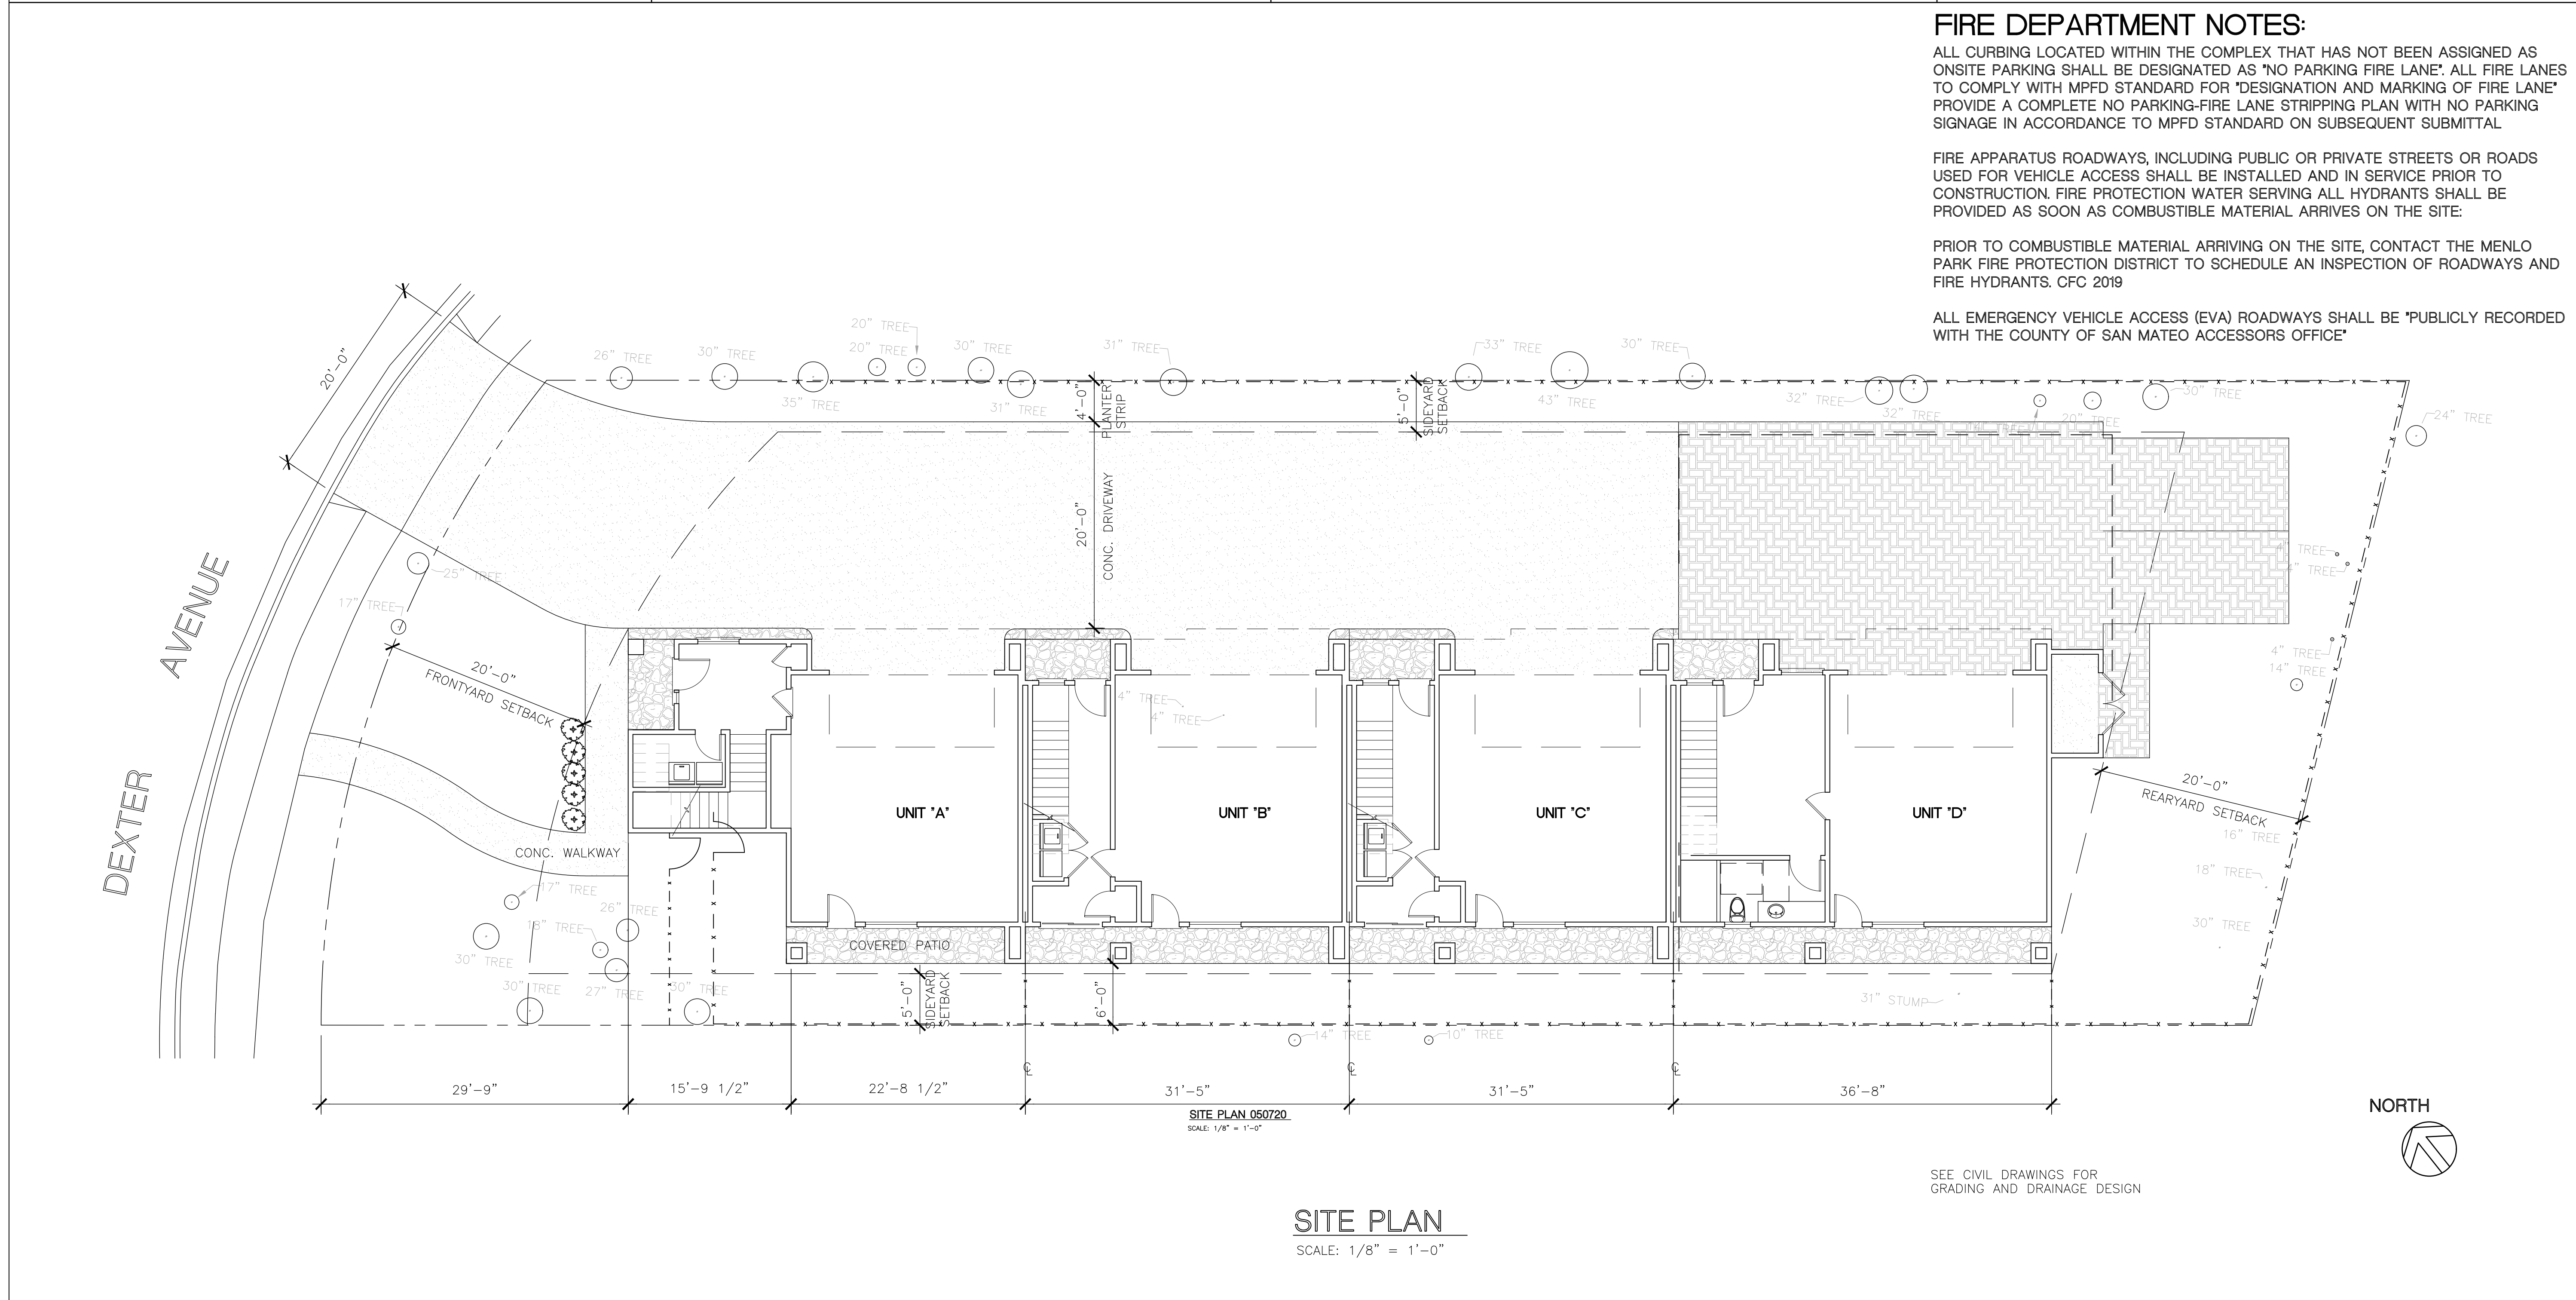

NO.	SUBMISSION/REVISION	DATE
△	SUBDIVISION	2-28-20
△	PLN. REV.	6-1-20
△		
△		
Drawing Title:  
**PROJECT DATA, SITE PLAN**

Drawing Status:  
**SITE DEVELOPMENT**

Drawn By: --- Checked By: --- Date: ---

Project Number: ---

Scale:  
1/8" = 1'-0"


Drawing Number:  
**SK-1**

# DL Architecture & Planning

616 RAMONA ST. STE 21  
PALO ALTO, CA 94301  
(650) 321-2808

This document constitutes original copyrighted material produced as an instrument of service by Architect Eric Kang. These documents shall not be utilized and/or duplicated without the permission of the Architect in writing. The design remains the sole property of Eric Kang and/or DL Architecture & Planning.

Seals:

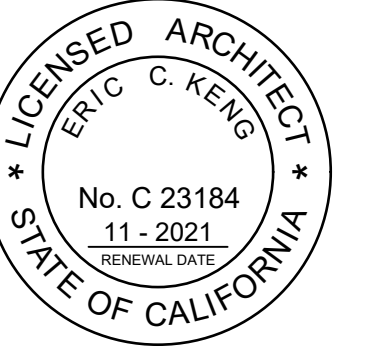

Client:

**DEXTER VILLA**  
---  
---  
**20 DEXTER AVENUE**  
**REDWOOD CITY, CA**

NO.	SUBMISSION/REVISION	DATE
△	SUBDIVISION	2-28-20
△	PLN. REV.	6-1-20
△		
△		
Drawing Title:  
**FLOOR PLANS & ROOF PLAN**

Drawing Status: **SITE DEVELOPMENT**

Drawn By: --- Checked By: --- Date: ---

Project Number: ---


Scale: **1/8" = 1'-0"**

Drawing Number: ---

**SK-2**


## ROOF PLAN

SCALE: 1/8" = 1'-0"

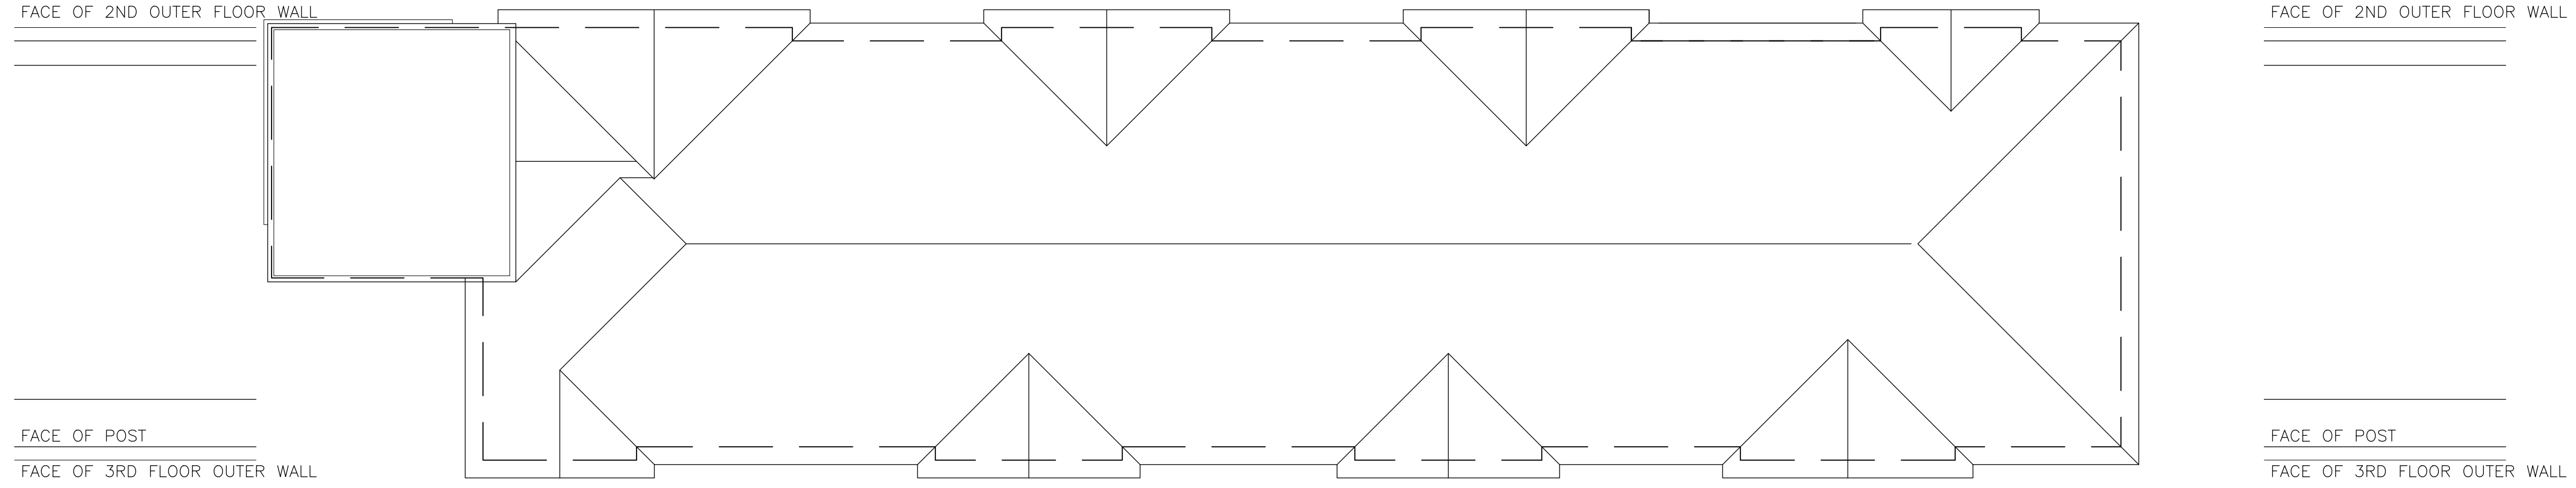


## 3rd FLOOR PLAN

SCALE: 1/8" = 1'-0"

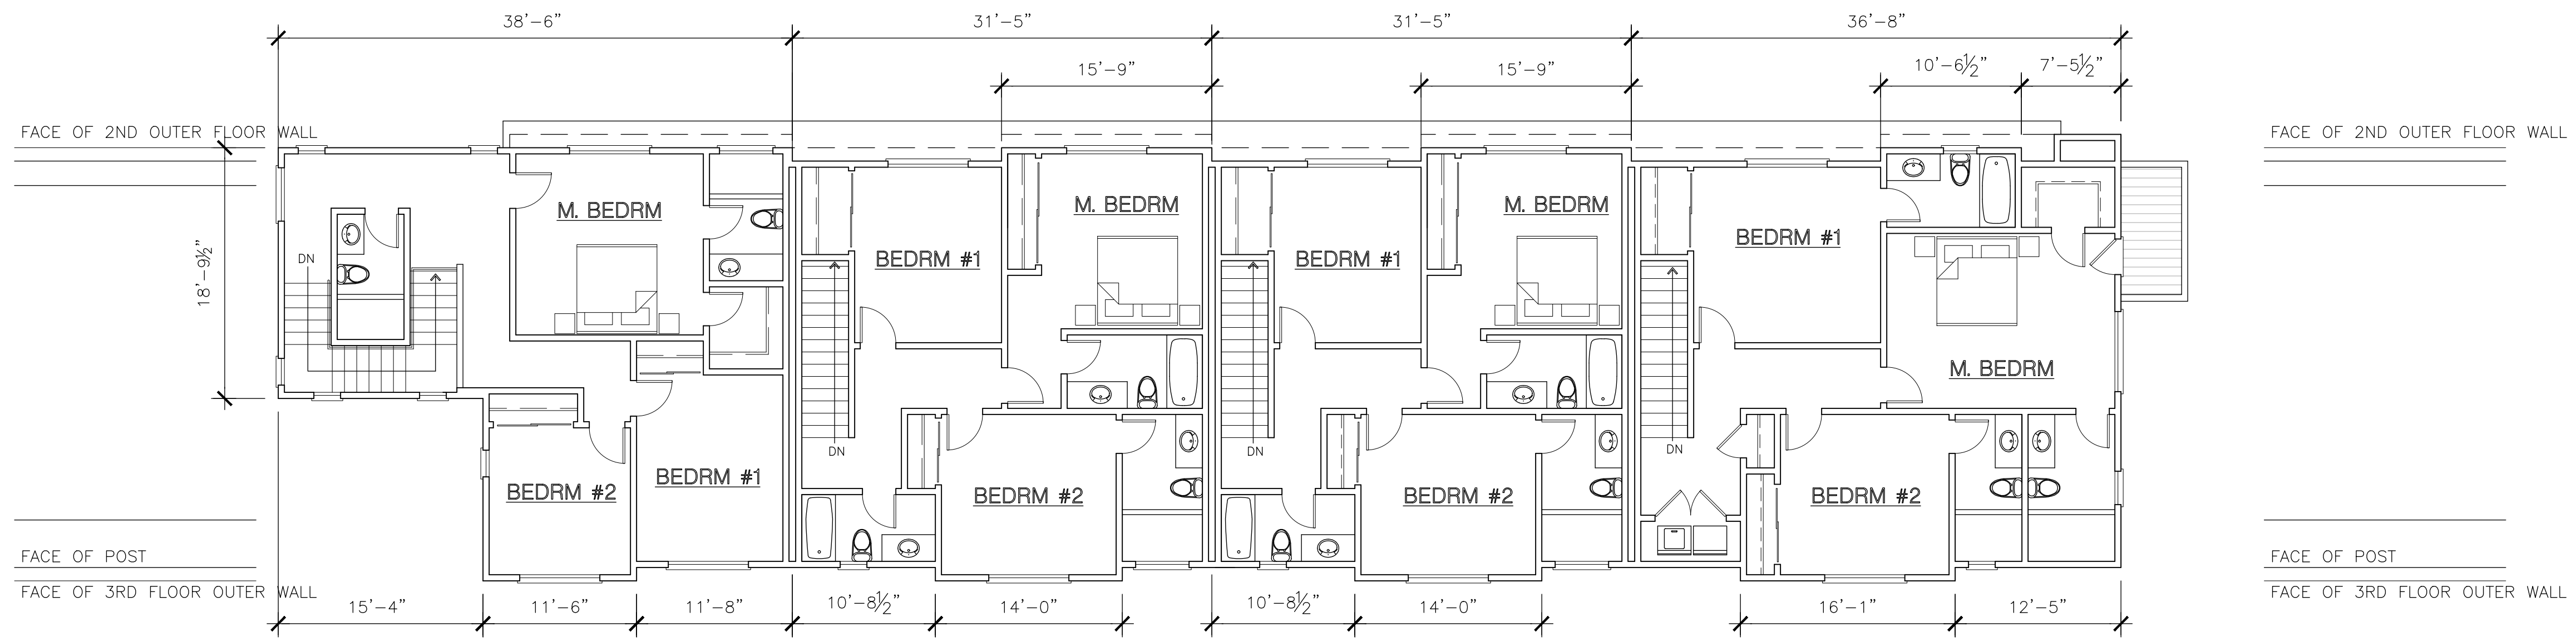



## 2nd FLOOR PLAN

SCALE: 1/8" = 1'-0"

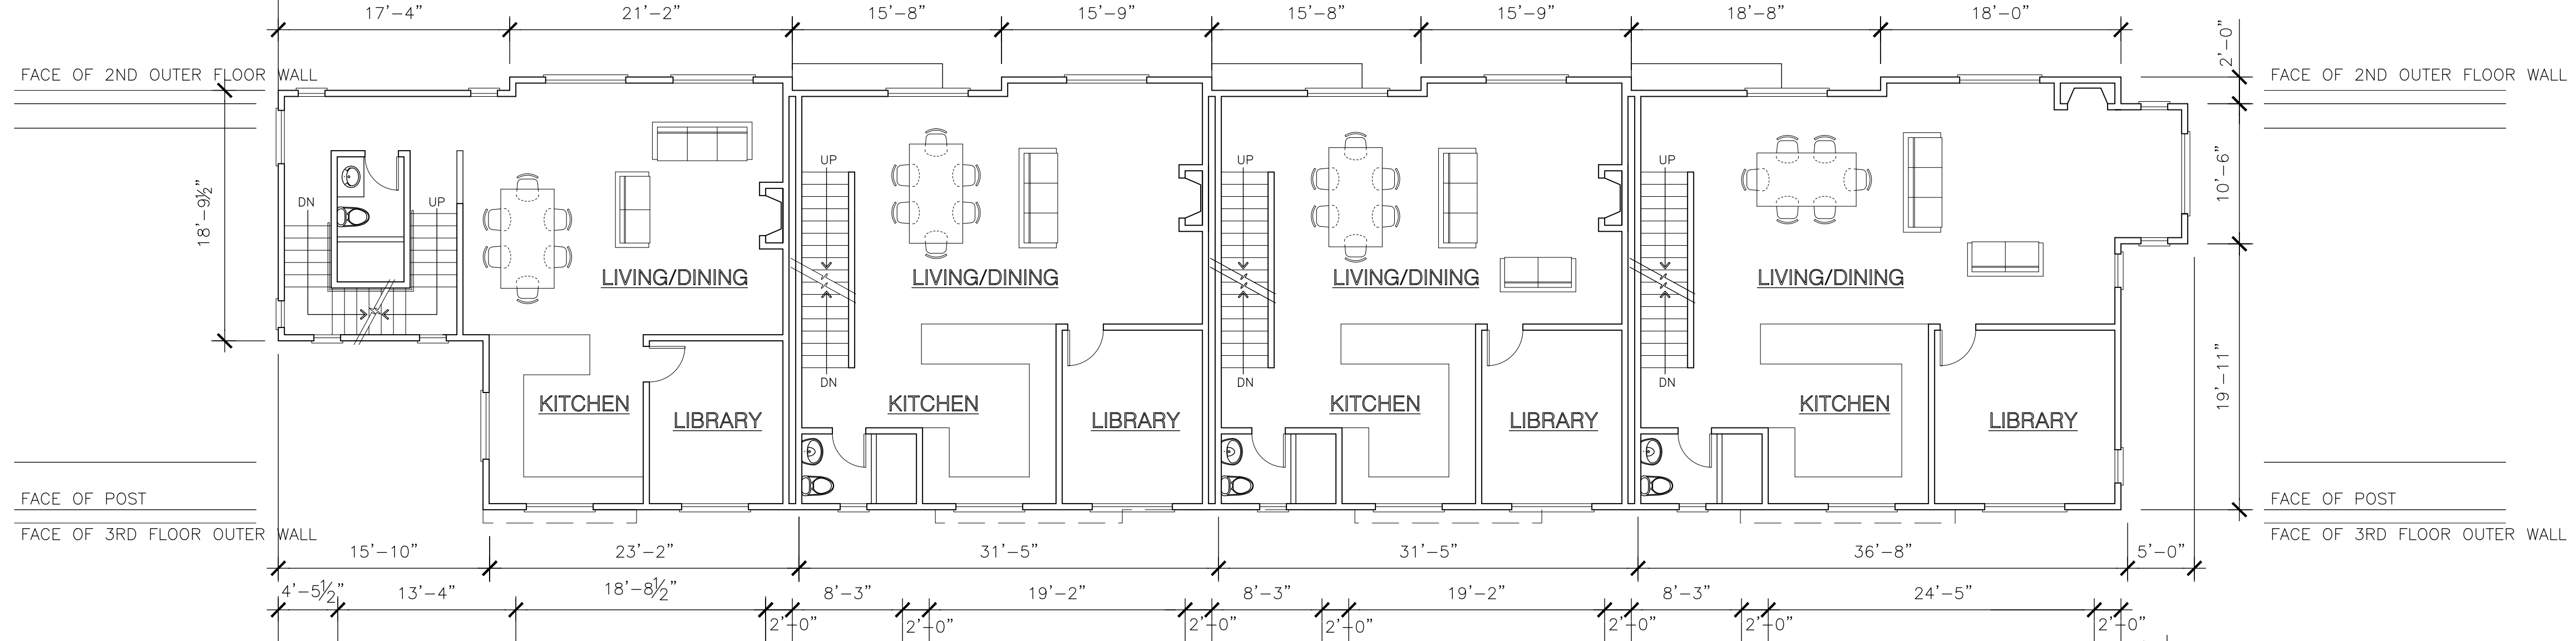

## 1st FLOOR PLAN

SCALE: 1/8" = 1'-0"

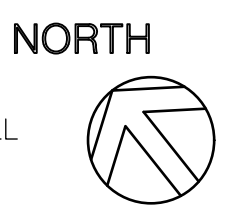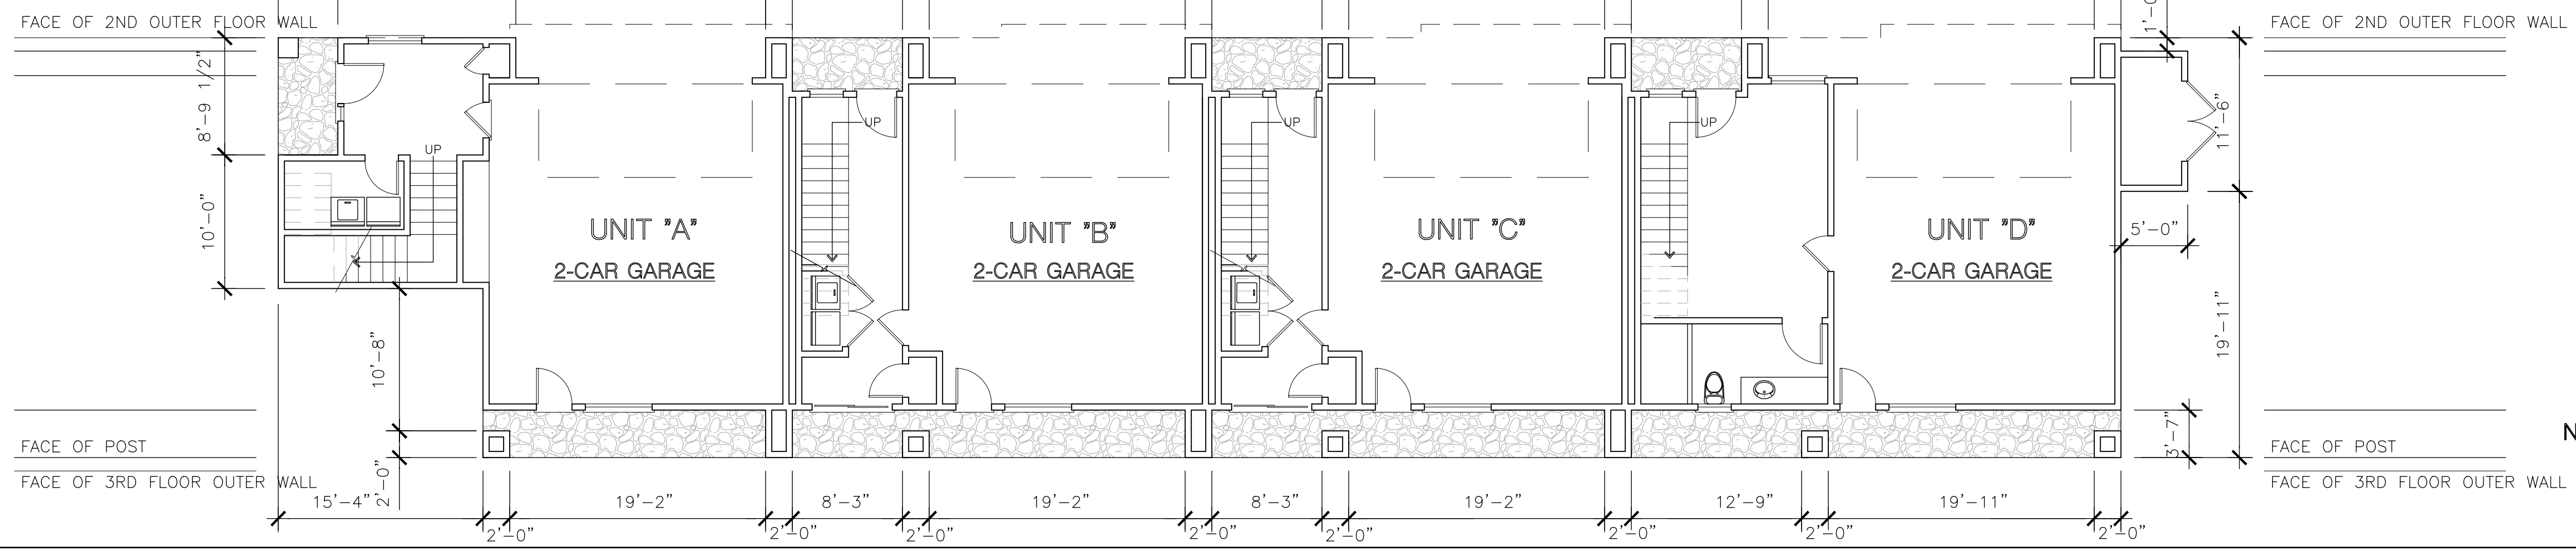





**MWELO SUBMITTAL CHECKLIST**

Submittal Date: 5/26/20  
 Project Address: 20 Dexter Ave., Redwood City  
 Applicant Name: Gregory Lewis Landscape Architect Phone: (831) 359-0960

The following checklist provides a list of information that must be included on the plans before your permit application can be processed. This checklist covers both the performance compliance method and the prescriptive compliance method. Please indicate which compliance method is used and provide the appropriate information on the plans.

- Performance Approach       Prescriptive Approach (Skip to Page Three)

**PERFORMANCE APPROACH**

**Landscape Documentation Package (Title 23, Chapter 2.7 §492.3)**

- The project's address, total landscape area, water supply type, and contacts shall be stated on the plans.
- Add, sign and date the following statement on the plans: "I agree to comply with the requirements of the water efficient landscape ordinance and submit a complete Landscape Documentation Package."
- Water Efficient Landscape Worksheet that includes a hydrozone information table and water budget calculations shall be submitted for plan check.
- A landscape design plan and irrigation design plan shall be submitted for plan check.

**Water Efficient Landscape Worksheet (Title 23, Chapter 2.7 §492.4 and §492.13)**

- Incorporate the Water Efficient Landscape Worksheet into plans. Show that the Maximum Applied Water Allowance (MAWA) meets or exceeds the calculated Estimated Total Water Use (ETWU).
- The evapotranspiration adjustment factor (ETAF) for the landscape project shall not exceed a factor of (0.55 for residential areas) (0.45 for non-residential areas).
- The plant factor used shall be from WUCOLS or from horticultural researchers with academic institutions. WUCOLS plants database can be found on-line at: <http://ucanr.edu/sites/WUCOLS/>
- All water features shall be included in the high water use hydrozone. All temporary irrigated areas shall be included in the low water use hydrozone.
- All Special Landscape areas shall be identified on the plans. The ETAF for new and existing (non-rehabilitated) Special Landscape Areas shall not exceed 1.0.
- For the purpose of calculating ETWU, the irrigation efficiency is assumed to be 0.75 for overhead spray devices and 0.81 for drip system devices.

**Landscape Design Plan (Title 23, Chapter 2.7 §492.6)**

- The landscape design plans, at a minimum, shall:
  - Delineate and label each hydrozone by number, letter, or other methods.
  - Identify each hydrozone as low, moderate, high water, or mixed water use.
  - Identify recreational areas, areas solely dedicated to edible plants, areas irrigated with recycled water, type and surface area of water features, impermeable and permeable hardscape, and any infiltration systems.
- For hydrozone with a mix of both low and moderate water use plants or both moderate and high water use plants, the higher plant factor or the plant factor based on the proportions of the respective plant water uses shall be used. Hydrozones containing a mix of low and high water use plants is not permitted.

- Turf is not allowed on slopes greater than 25% where the toe of the slope is adjacent to an impermeable hardscape.
- Add note to plans: "Recirculating water systems shall be used for water features"
- Add note to plans: "A minimum 3-inch layer of mulch shall be applied on all exposed soil surfaces of planting areas except turf areas, creeping or rooting groundcovers, or direct seeding applications where mulch is contraindicated."
- Add note to plans: "For soils less than 6% organic matter in the top 6 inches of soil, compost at a rate of a minimum of four cubic yards per 1,000 square feet of permeable area shall be incorporated to a depth of six inches into the soil"

**Irrigation Design Plan (Title 23, Chapter 2.7 §492.7)**

- The irrigation plans, at a minimum, shall contain the following:
  - Location and size of spate water meters for landscape
  - Location, type, and size of all components of the irrigation system, including controllers, main and lateral lines, valves, sprinkler heads, moisture sensing devices, rain switches, quick couplers, pressure regulators, and backflow prevention devices.
  - Static water pressure at the point of connection the public water supply
  - Flow rate (gallons per minute), application rate (inches per hour), and design operating pressure (pressure per square inch) for each station.
- A dedicated water service meter or private submeter shall be installed for all (non-residential irrigated landscapes of at least 1,000sqft) (residential irrigated landscape areas of at least 5,000sqft).
- Add note to plans: "Pressure regulating devices are required if water pressure is below or exceeds the recommended pressure of the specified irrigation devices."
- Manual shut-off valves shall be required, as close as possible to the point of connection of the water supply, to minimize water loss in case of an emergency or routine repair.
- Add note to plans: "Check valves or anti-drain valves are required on all sprinkler heads where low point drainage could occur."
- Areas less than 10-feet in width in any direction shall be irrigated with subsurface or drip irrigation.
- Overhead irrigation shall not be permitted within 24-inches of any non-permeable surface.

**Required Statements and Certification (Title 23, Chapter 2.7 §492.6, §492.7 and §492.9)**

- Add the following statement on the landscape and irrigation plans: "I have complied with the criteria of the ordinance and applied them for the efficient use of water in the landscape design plans"
- The final set of landscape and irrigation plans shall bear the signature of a licensed landscape architect, licensed landscape contractor, certified irrigation designer, licensed architect, licensed engineer, licensed land surveyor, or personal property owner.
- Add note to plans: "A diagram of the irrigation plan showing hydrozones shall be kept with the irrigation controller for subsequent management purposes."
- Add note to plans: "A Certificate of Completion shall be filled out and certified by either the designer of the landscape plans, irrigation plans, or the licensed landscape contractor for the project".
- Add note to plans: "An irrigation audit report shall be completed at the time of final inspection."

**PRESCRIPTIVE APPROACH  
 (For landscape areas between 500 and 2,499 square feet)**

**Plant Material (Title 23, Chapter 2.7, Appendix D (b) (3))**

- For residential areas, 75% of landscape, excluding edibles and areas using recycled water, shall consist of plants that average a WUCOLS plant factor of 0.3. WUCOLS plants database can be found online at: <http://ucanr.edu/sites/WUCOLS/>
- For non-residential areas, 100% of the plants, excluding edibles and areas using recycled water, shall consist of plants that average a WUCOLS plant factor of 0.3.
- Add note to plans: "A minimum 3-inch layer of mulch shall be applied on all exposed soil surfaces of planting areas except turf areas, creeping or rooting groundcovers, or direct seeding applications where mulch is contraindicated."

**Turf (Title 23, Chapter 2.7, Appendix D (b) (4))**

- Turf shall not exceed 25% of the landscape area in residential areas.
- No turf permitted in non-residential areas
- Turf not permitted on slopes greater than 25%.
- Turf is prohibited in parkways less than 10 feet wide.

**Irrigation (Title 23, Chapter 2.7, Appendix D (b) (5))**

- Automatic weather-based or soil-moisture based irrigation controllers shall be installed on the irrigation system.
- Pressure regulators shall be installed on the irrigation system to ensure dynamic pressure of the system is within the manufacturer's recommended pressure range.
- Manual-shut-off valves shall be installed as close as possible to the point of connection of the water supply.
- Areas less than 10-feet in width in any direction shall be irrigated with subsurface irrigation or other means that produces no runoff or overspray.
- For non-residential projects with landscape areas of 1,000sqft or more, private sub-meter(s) to measure landscape water use shall be installed.
- Add note to plans: "At the time of final inspection, the permit applicant must provide the owner of the property with a certificate of completion, certificate of installation, irrigation schedule of landscape and irrigation maintenance."
- Add note to plans: "Unless contradicted by a soils test, compost at a rate of a minimum of four cubic yards per 1,000 square feet of permeable area shall be incorporated to a depth of six inches into the soil"

The landscape contractor is to follow all of the County of San Mateo landscape and irrigation check list requirements.

**Hydrozone Summary**

HYDROZONE	VALVES	IRRIG. METHOD	AREA sq.ft.	% of LANDSCAPE AREA
1 Low water shrub	1	Drip	556	100%
<b>TOTAL</b>			556	100%
Summary by Hydrozone				
High Water Use	0	0%		
Moderate Water use	0	0%		
Low Water Use	556	100%		
<b>TOTAL</b>	556	100%		

**WATER EFFICIENT LANDSCAPE WORKSHEET**

Date: 5/12/2020 5/26/20  
 Project: Two Duplexes  
 Address: 20 Dexter Ave., Redwood City  
 Total Planted Area (sq.ft.) 556

Reference Evapotranspiration (Eto): 43 Palo Alto/Los Altos/Redwood City									
HYDRO ZONE NO.	VALVES	HYDRO ZONE DESC.	Plant Factor PF	Irrig. Method	Irrig. Efficiency IE	ETAF PF/IE	LDSCP AREA Square Feet	ETAF x Area	Estimated Total Water Use (Gal.)

Regular Landscape Areas									
1	1	Drip, low water, shrub	0.3	Drip	0.81	0.3704	556	205.93	5,490
2									
3									
4									
5									
6									
7									
8									
<b>Totals</b>							556	206	5,490

Special Landscape Areas									
							1	0	
							1		
							1		
<b>Totals</b>							0		0
<b>ETWU Total</b>									5,490
<b>Maximum Allowed Water Allowance (MAWA)</b>									8,153

Residential ETAF for MAWA calc. 0.55 MAWA (Annual Gallons Allowed) = (Eto) (0.62) [(ETAF x LA) + ((1-ETAF) x SLA)]

**ETAF Calculations**

Regular Landscape Areas	
Total ETAF x Area	206
Total Area	556
Average ETAF	0.37

All Landscape Areas	
Total ETAF x Area	206
Total Area	556
Site-wide ETAF	0.37

Average total ETAF must be .55 or less for residential

**SHEET INDEX**



- L0 - LANDSCAPE DOCUMENTATION
- L1 - PLANTING PLAN
- L2 - IRRIGATION PLAN
- L3 - LANDSCAPE DETAILS
- L4 - LANDSCAPE SPECIFICATIONS

**Landscape Documentation**

Revision

- 3/2/20
- 5/26/20

GREGORY LEWIS LANDSCAPE ARCHITECT  
 1331 Park Way Santa Cruz, CA 95060 (831) 331-0000

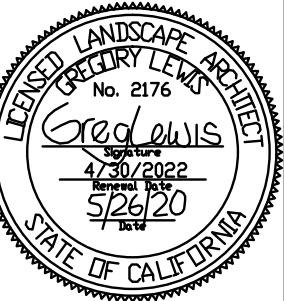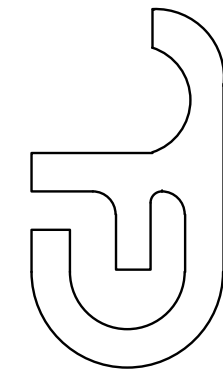

**Dexter Villa**  
 20 Dexter Avenue, Redwood City, CA

Date: 10/7/19  
 Scale: As Noted  
 Drawn: Greg



# Drip Irrigation Notes

- 1) Secure larger 3/4" drip tubing 1" below grade with 7" or 11" U-shaped stakes 3 feet on center or closer so that the tubing can be found easily but does not show if the mulch gets brushed away. Cover tubing with soil and mulch and install manual flush valves at ends of tubing and mark them so they can be found easily.
- 2) Run large tubing next to or over rootball of plants to minimize length of smaller 1/4" tubing. Secure emitters on 3/4" tubing at plant root balls. When necessary run short lengths of 1/4" tubing from emitters to plant root balls. Install stakes on 1/4" tubing at 12" on center and cover tubing with 1" of soil plus mulch.
- 3) As the plant and plant rootball increase in size, the locations of the emitters may need to be adjusted so they are evenly spaced over the rootball.
- 4) Install pressure compensating emitters (with minimal difference in flow between 10 PSI and 40 PSI) at each plant on root ball (not right at stem). Use Agrifim PC Plus (pressure compensating emitters). Use the ones that 1/4" tubing can be connected to. Other emitters may have a higher discharge rate at startup requiring larger pipe sizes.

Emitter schedule:  
Three 1 GPH emitters at small and medium shrubs and ground covers DV, LB, NC

With shrubs and trees that have multiple emitters, put some over root ball (not right on stem) and some out under future canopy. Space emitters evenly in root zone area.

3/4" PE drip tubing to come within 12" or closer of each plant with a minimum of 1/4" tubing just to get to other side of root ball. The Landscape Contractor is to ask for an inspection at least 3 working days in advance by the landscape architect or owner of the drip tubing and emitter layout prior to burying tubing 1 inch deep to make sure you are doing this.

# Irrigation Notes

- 1 See sheet L3 and L4 for details and specifications
- 2 This system is designed to operate with minimum 5 GPM at minimum 55 p.s.i. at the point of connection. If this condition is not met contact the Landscape Architect for possible redesign. If pressure exceeds 75 psi at point of connection install a Wilkins 600 1" pressure regulator. There is approx. \_\_\_\_\_ static psi at this site.
- 3 Detector tape should be installed with any pressure lines not buried in the same trench with control wires and with any lines of any kind under paving not in a trench with control wires.
- 4 At valve groupings provide a threaded capped pressure line stubout so it is easy to add additional valves later. Run a few extra wires to these locations from the controller - enough so that at least 2 valves could be added at any proposed valve grouping on the plan - especially in the rear yards that are not being landscaped by the developer.
- 5 Electric controllers should be set to water between 6:00 PM and 11:00 a.m. to avoid watering during times of higher wind or temperature and programmed with repeat cycles to avoid runoff. This is not as important for drip that is not affected by the wind. Set irrigation schedule according to plants' water needs.
- 6 The routing of sprinkler lines is schematic on the plan. Do not put valves too close to trees. Stay 8' to 10' away if possible. Do not put pressure lines under trees. Install line in planting areas instead of under paving whenever possible.
- 7 Check with the owner for final location of controller so it can be coordinated with the electrical supply. Run sleeves under driveways and other paving for wires and irrigation lines.
- 8 Add enough hosebibs so that there is a hosebib on the proposed homes or on the irrigation system so that a 50 foot long hose can reach all planter areas from one of the hose bibs.
- 9 An irrigation audit may be required by an independent irrigation auditor as per 492.12 Irrigation Audit of the most recent State MWEL. The irrigation auditor is to provide an irrigation schedule for plants during the establishment period when they need more water and a base schedule for when the plants need less water after establishment. He/she should also provide irrigation parameters used to set the controller as per 492.10 Irrigation Scheduling in the most recent version of the State MWEL.
- 10 All irrigation emission devices must meet the requirements set in the ANSI standard ASABE/ICC 802-2014. "Landscape Irrigation Sprinkler and Emitter Standard" All sprinkler heads installed in the landscape must document a distribution uniformity low quarter of 0.65 or higher using the protocol defined in ASABE/ICC 802-2014
- 11 Pressure regulating devices are required if water pressure is below or exceeds the recommended pressure of the specified irrigation devices
- 12 Check valves or anti-drain valves are required on all sprinkler heads where low point drainage could occur
- 13 Soil moisture levels need to be brought up by hand watering or a temporary spray system before the drip system can take over.
- 14 The contractor is to provide a diagram of the irrigation plan showing hydrozones that shall be kept with the irrigation controller for subsequent management purposes
- 15 The contractor is to provide an "as built" drawing of any significant changes such as pressure line and valve location changes
- 16 A Certificate of Completion shall be filled out and certified by either the designer of the landscape plans, irrigation plans, or the licensed landscape contractor for the project
- 17 An irrigation audit report shall be completed at the time of final inspection

# Irrigation Legend

KEY	MANUF.	MANUF. #	DESCRIPTION
	Hunter	Pro-C	4 station Controller expandable for more stations wall mount exterior with Wireless Solar Sync On-Site Weather Station. Controller will change it's program based on current weather conditions. Install weather sensor in a sunny location where it will get rain
	Hunter	PGV 101G	Automatic master valve 1"
			Private 3/4" Water Meter below grade in valve box at point of connection this will keep track of irrigation water use and help find leaks
			1" Manual brass shutoff valve in valve box same size as pressure line
	Hunter	PGV-ASV 075	3/4" antisiphon valve with 3/4" Amiad Filter, Senniger PR30 pressure regulator, and adaptor to drip tubing
	Champion		Hose bib below grade in 10" valve box with ball down lid with outlet pointed up for easy hose connection See Irrigation Note #8.

HYDROZONE	VALVES	IRRIG. METHOD	AREA sq.ft.	% of LANDSCAPE AREA
3/4" low water shrub	1	Nonpressure line - Sch 40 PVC 3/4" unless noted for larger size - 12" cover - pipes less than 2" to be Sch 40 PVC	556	100%
1-1/4" Primary by Hydrozone			Area (Sq.ft.)	% of Landscape Area
High Water Use	0	0%		
Moderate Water Use	0	0%		
Low Water Use	556	100%	556	100%
TOTAL			556	100%


PL	Description
PL	Pressure line - 1" Sch 40 PVC
NP	Non Pressure line - 1" Sch 40 PVC
WI	1-1/2" gray elec. conduit for control wires.

Also install an extra capped 1" water line for future use under paving

3/4" PE drip tubing with compression fittings - see Drip Irrigation Notes

3/4" PE drip tubing with compression fittings at tree - see Drip Irrigation Notes


All lines under pavement to be sleeved using a Sch 40 PVC sleeve 2 sizes larger than the pipe inside

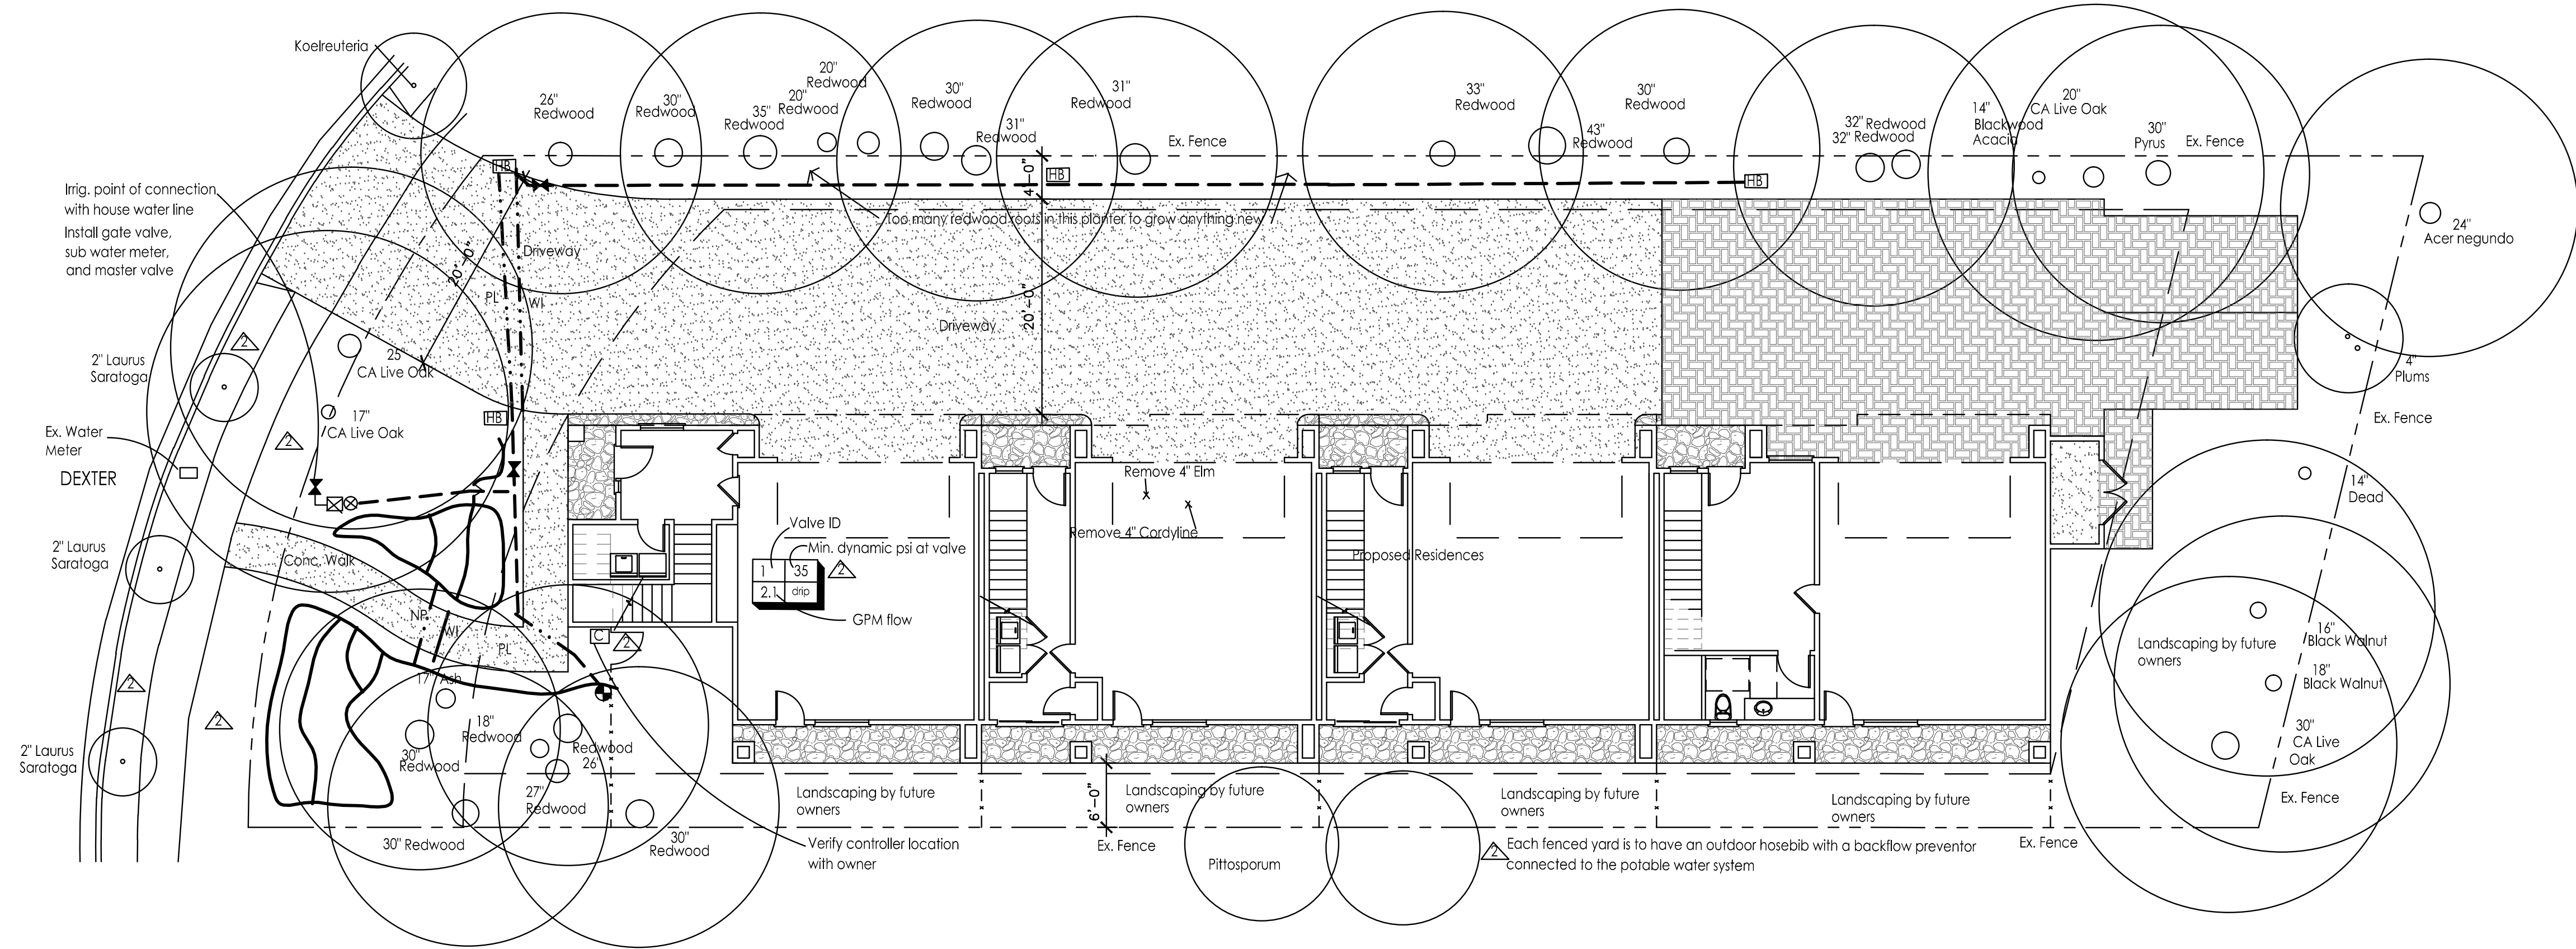

"I have complied with the criteria of the MWEL ordinance and applied them for the efficient use of water in the irrigation design plans" Greg Lewis 5/26/20


# Irrigation Plan

1"=10'-0"  
0' 10' 20'

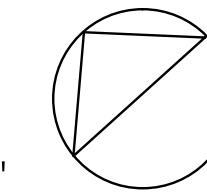


Revision  
3/2/20  
5/26/20

GREGORY LEWIS LANDSCAPE ARCHITECT  
1333 Park Way Santa Cruz, CA 95061-3100

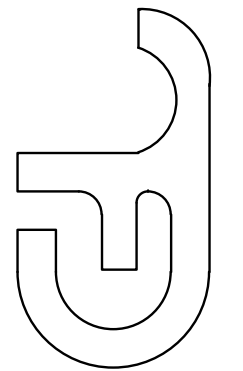

Dexter Villa  
20 Dexter Avenue, Redwood City, CA


Date 10/7/19  
Scale As Noted  
Drawn Greg  
Job Sheet  
5 of L2

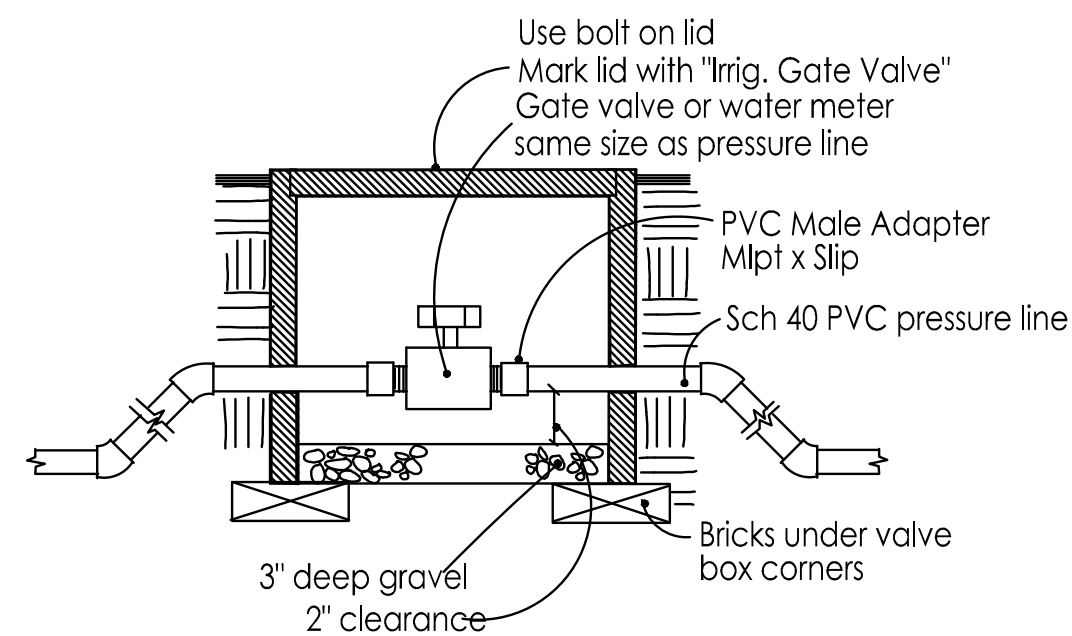

**Manual Gate Valve**

No Scale


A

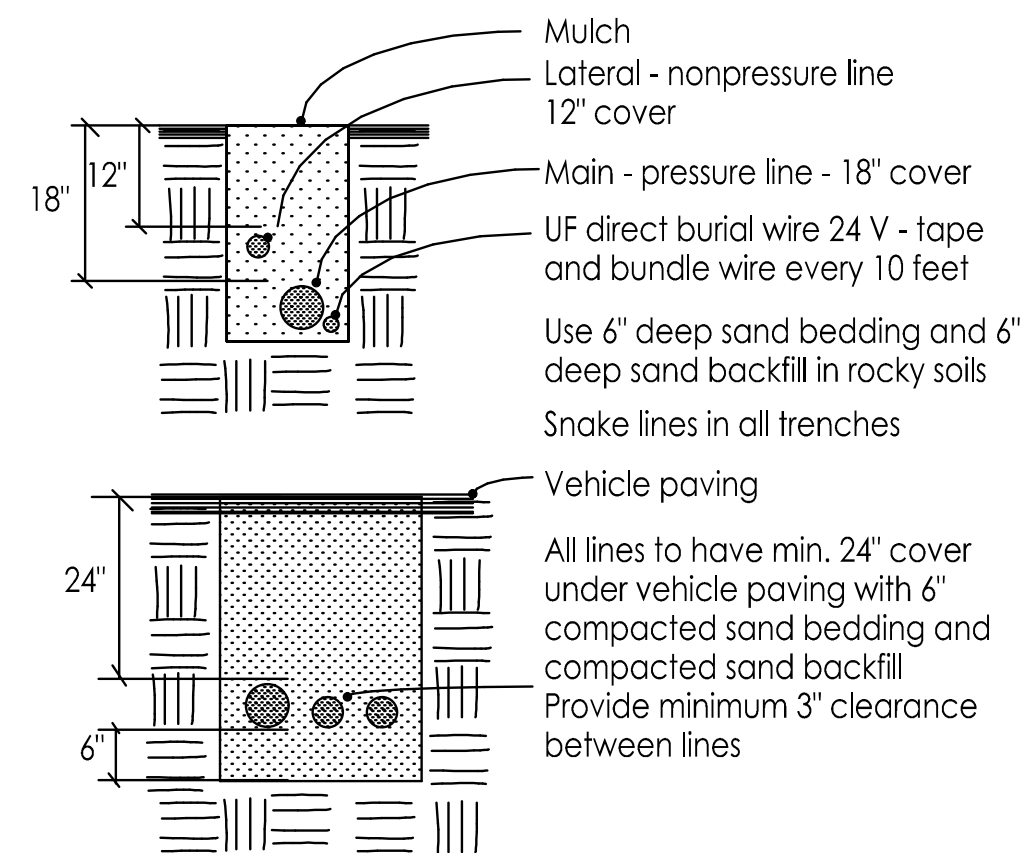

**Trenches/Lines**

No Scale


B

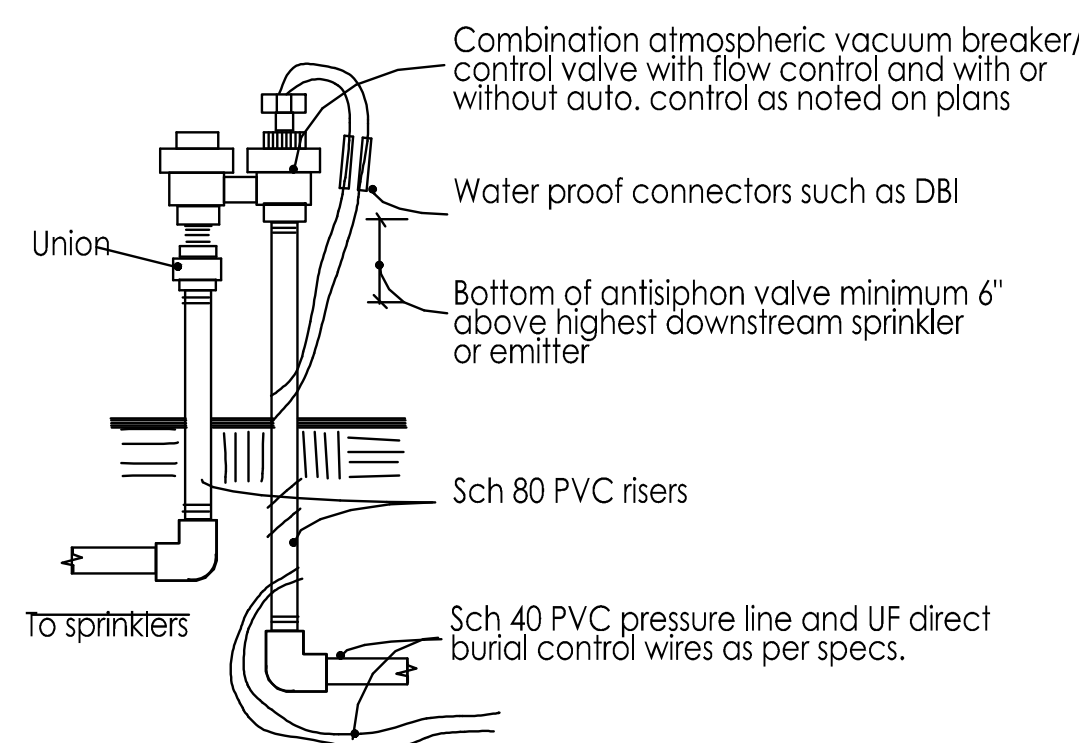

**Auto. Antisiphon Valve**

No Scale

C

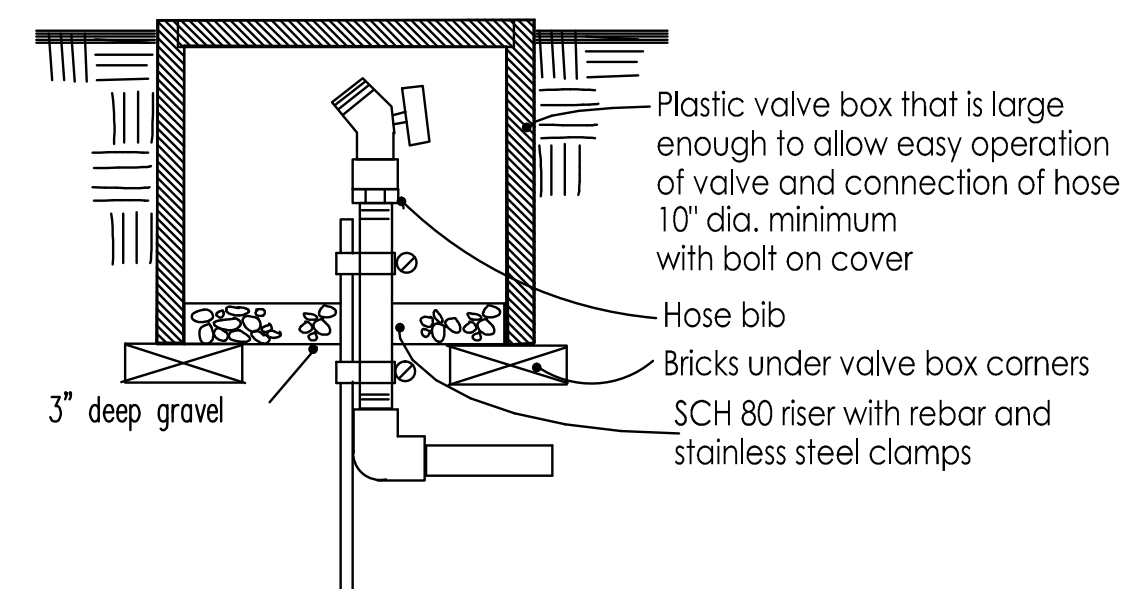


**Hose Bibb**

**Below Grade**

No Scale


D

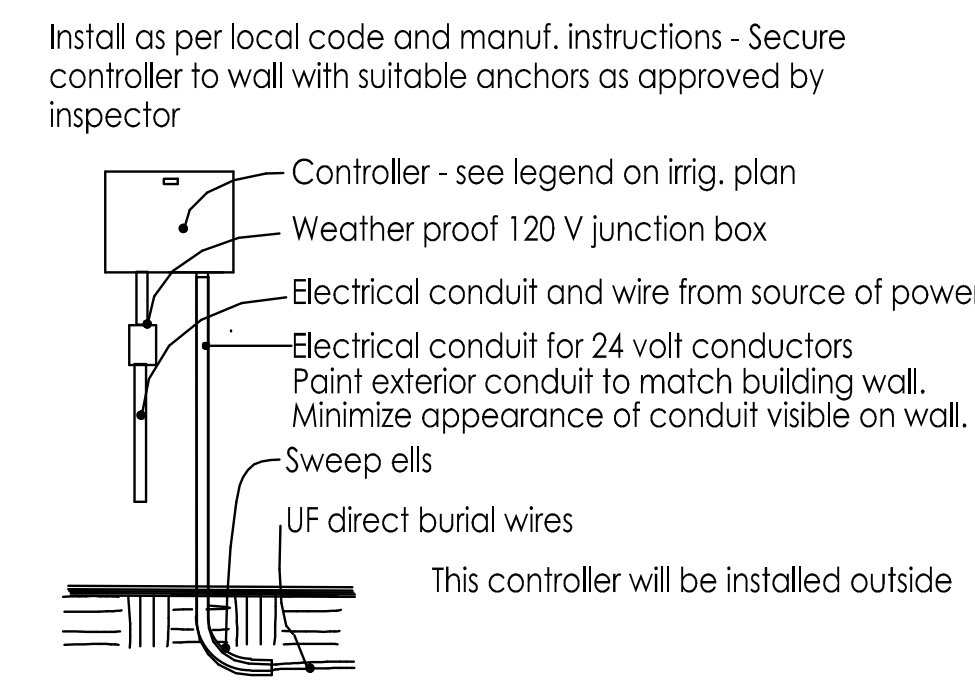

**Wall Mount Controller**

No Scale


E

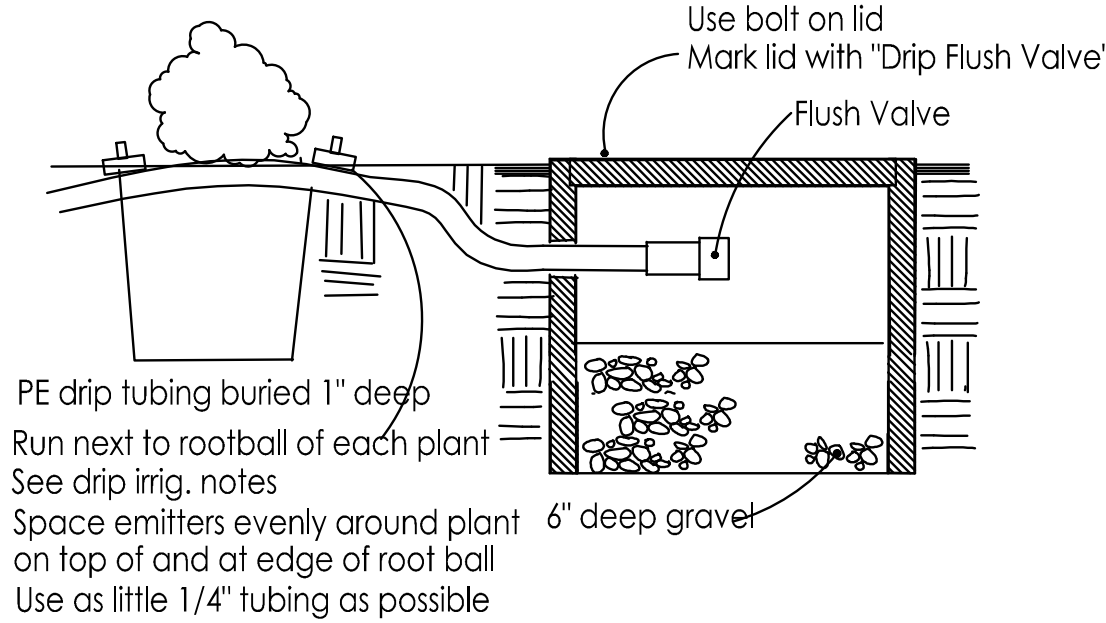

**Drip Emitter and Flush Valve**

No Scale


F

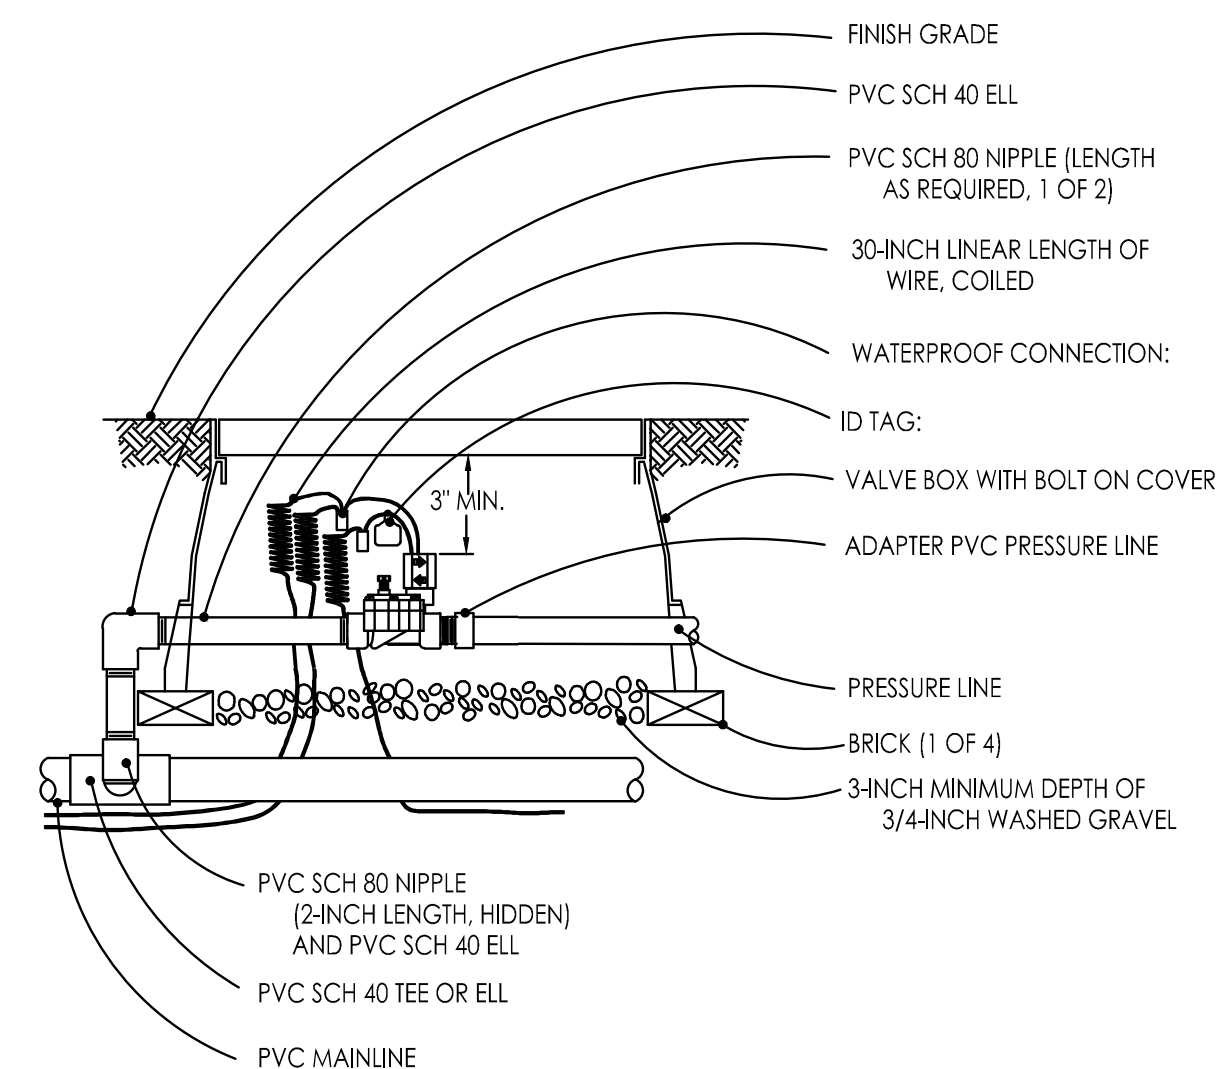

**Remote Control Master Valve**

No Scale

G

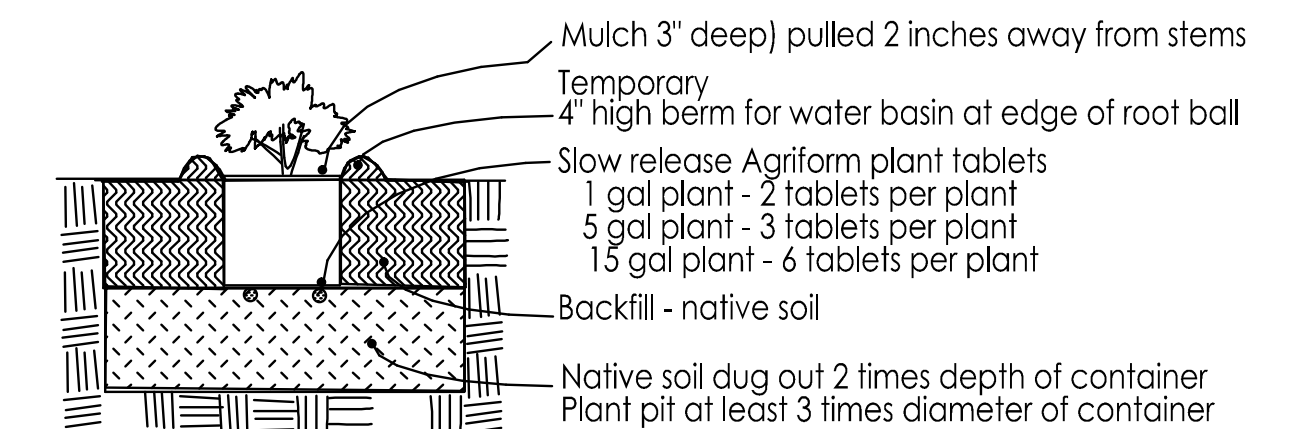


- 1) 8 - 12 hours before installation, water all plants while still in containers sufficiently to thoroughly wet root balls
- 2) Dig the plant hole at least 3 times the dia. and 2 times the depth of the plant container.
- 3) Replace this mixture in bottom half of hole and walk on it. The level of it should be such that when the plant is installed and settled it will be slightly above grade of existing soil. Fill hole with water.
- 4) Remove rootball carefully from container by tapping out, not pulling out by the stem. Scarify rootball walls in 3 vertical cuts and bottom to 1/2" deep, or by cutting roots of 1/2" or larger with shears. Do not pull roots apart.
- 5) Install fertilizer packets under rootball of plant. Set rootball on prepared surface and fill hole to 1/2 the depth, tamping soil around rootball. Fill hole with water.
- 6) Fill the remainder of the hole with backfill and pack it but do not tamp rootball.
- 7) Make the water basin.
- 8) Water shrub thoroughly within 1 hour of planting by filling the basin and allowing the water to percolate in, doing this 3 times or more until root ball and backfill is wet
- 9) Install mulch

**Shrub Planting**

No Scale

○

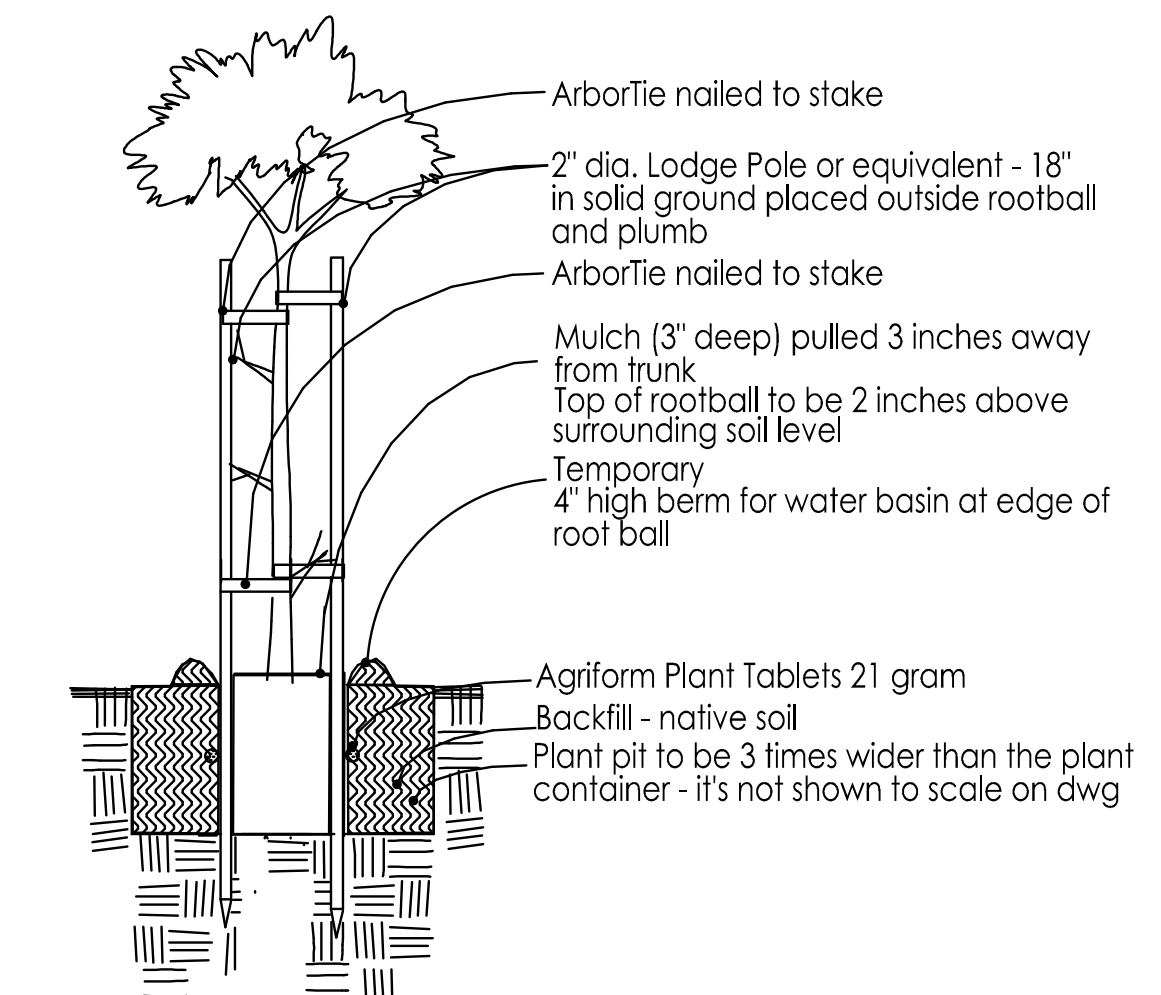

- 1) 8 - 12 hours before installation, water all plants while still in containers sufficiently to thoroughly wet root balls
- 2) Dig hole at least 2" less deep than the container and 3 times wider than the diameter of the container the plants were delivered in.
- 3) Gauge holes in the side of the plant pit - 2 holes per sq. ft. of wall surface
- 4) Remove rootball carefully from container with support from below. Sever any circling roots (3/16" dia. or greater) with sharp knife. Do not pull roots apart. The severing of large roots will encourage new roots at the cuts. Install enough backfill under root ball so top of rootball ends up 2" above grade of surrounding soil when it settles. Install some of fertilizer packets under root ball.
- 5) Fill around rootball with backfill mix to 1/2 its height and pack soil as you fill with shovel handle or feet being careful not to disturb root ball
- 6) Put Agriform Plant Tablet fertilizer at this level adjacent to rootball and at bottom of hole (5 tablets per 15 gal. or 5 tablets per 1 inch of caliper width. Fill the remainder of the hole with backfill and pack it.
- 7) Water tree thoroughly by filling the basin and allowing the water to percolate in, doing this 3 times or more until root ball and backfill is wet
- 8) Install stakes such that the stakes and the tree lies won't damage the tree and the stakes won't lean toward each other. Cut off tops of stakes if necessary to lower below branches that could be rubbed by stakes. Install stakes so they are straight up and don't lean in to each other

**Tree Planting**



No Scale

○

Revision

- 3/2/20
- 5/26/20

GREGORY LEWIS LANDSCAPE ARCHITECT  
1311 Park Way Santa Cruz, CA 95060 831.333.0100

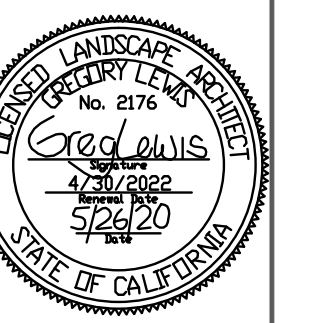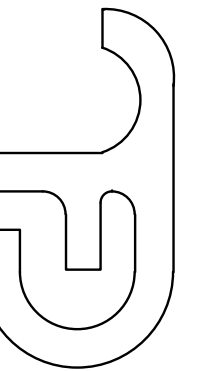

**Dexter Villa**  
20 Dexter Avenue, Redwood City, CA

Date: 10/7/19  
Scale: As Noted  
Drawn: Greg


Job Sheet: L3  
of 5



DRAWING NAME: K:\2019\190603\_20\_Dexter\_Ave\_RWC\ENR\EXHIBITS\Fig 1.dwg (Layout)  
 PLOT TIME: 6/10/2020 10:49 AM


EAST SELBY LANE  
 (60' R/W - A PUBLIC STREET)

DEXTER AVENUE  
 (60' R/W - A PUBLIC STREET)

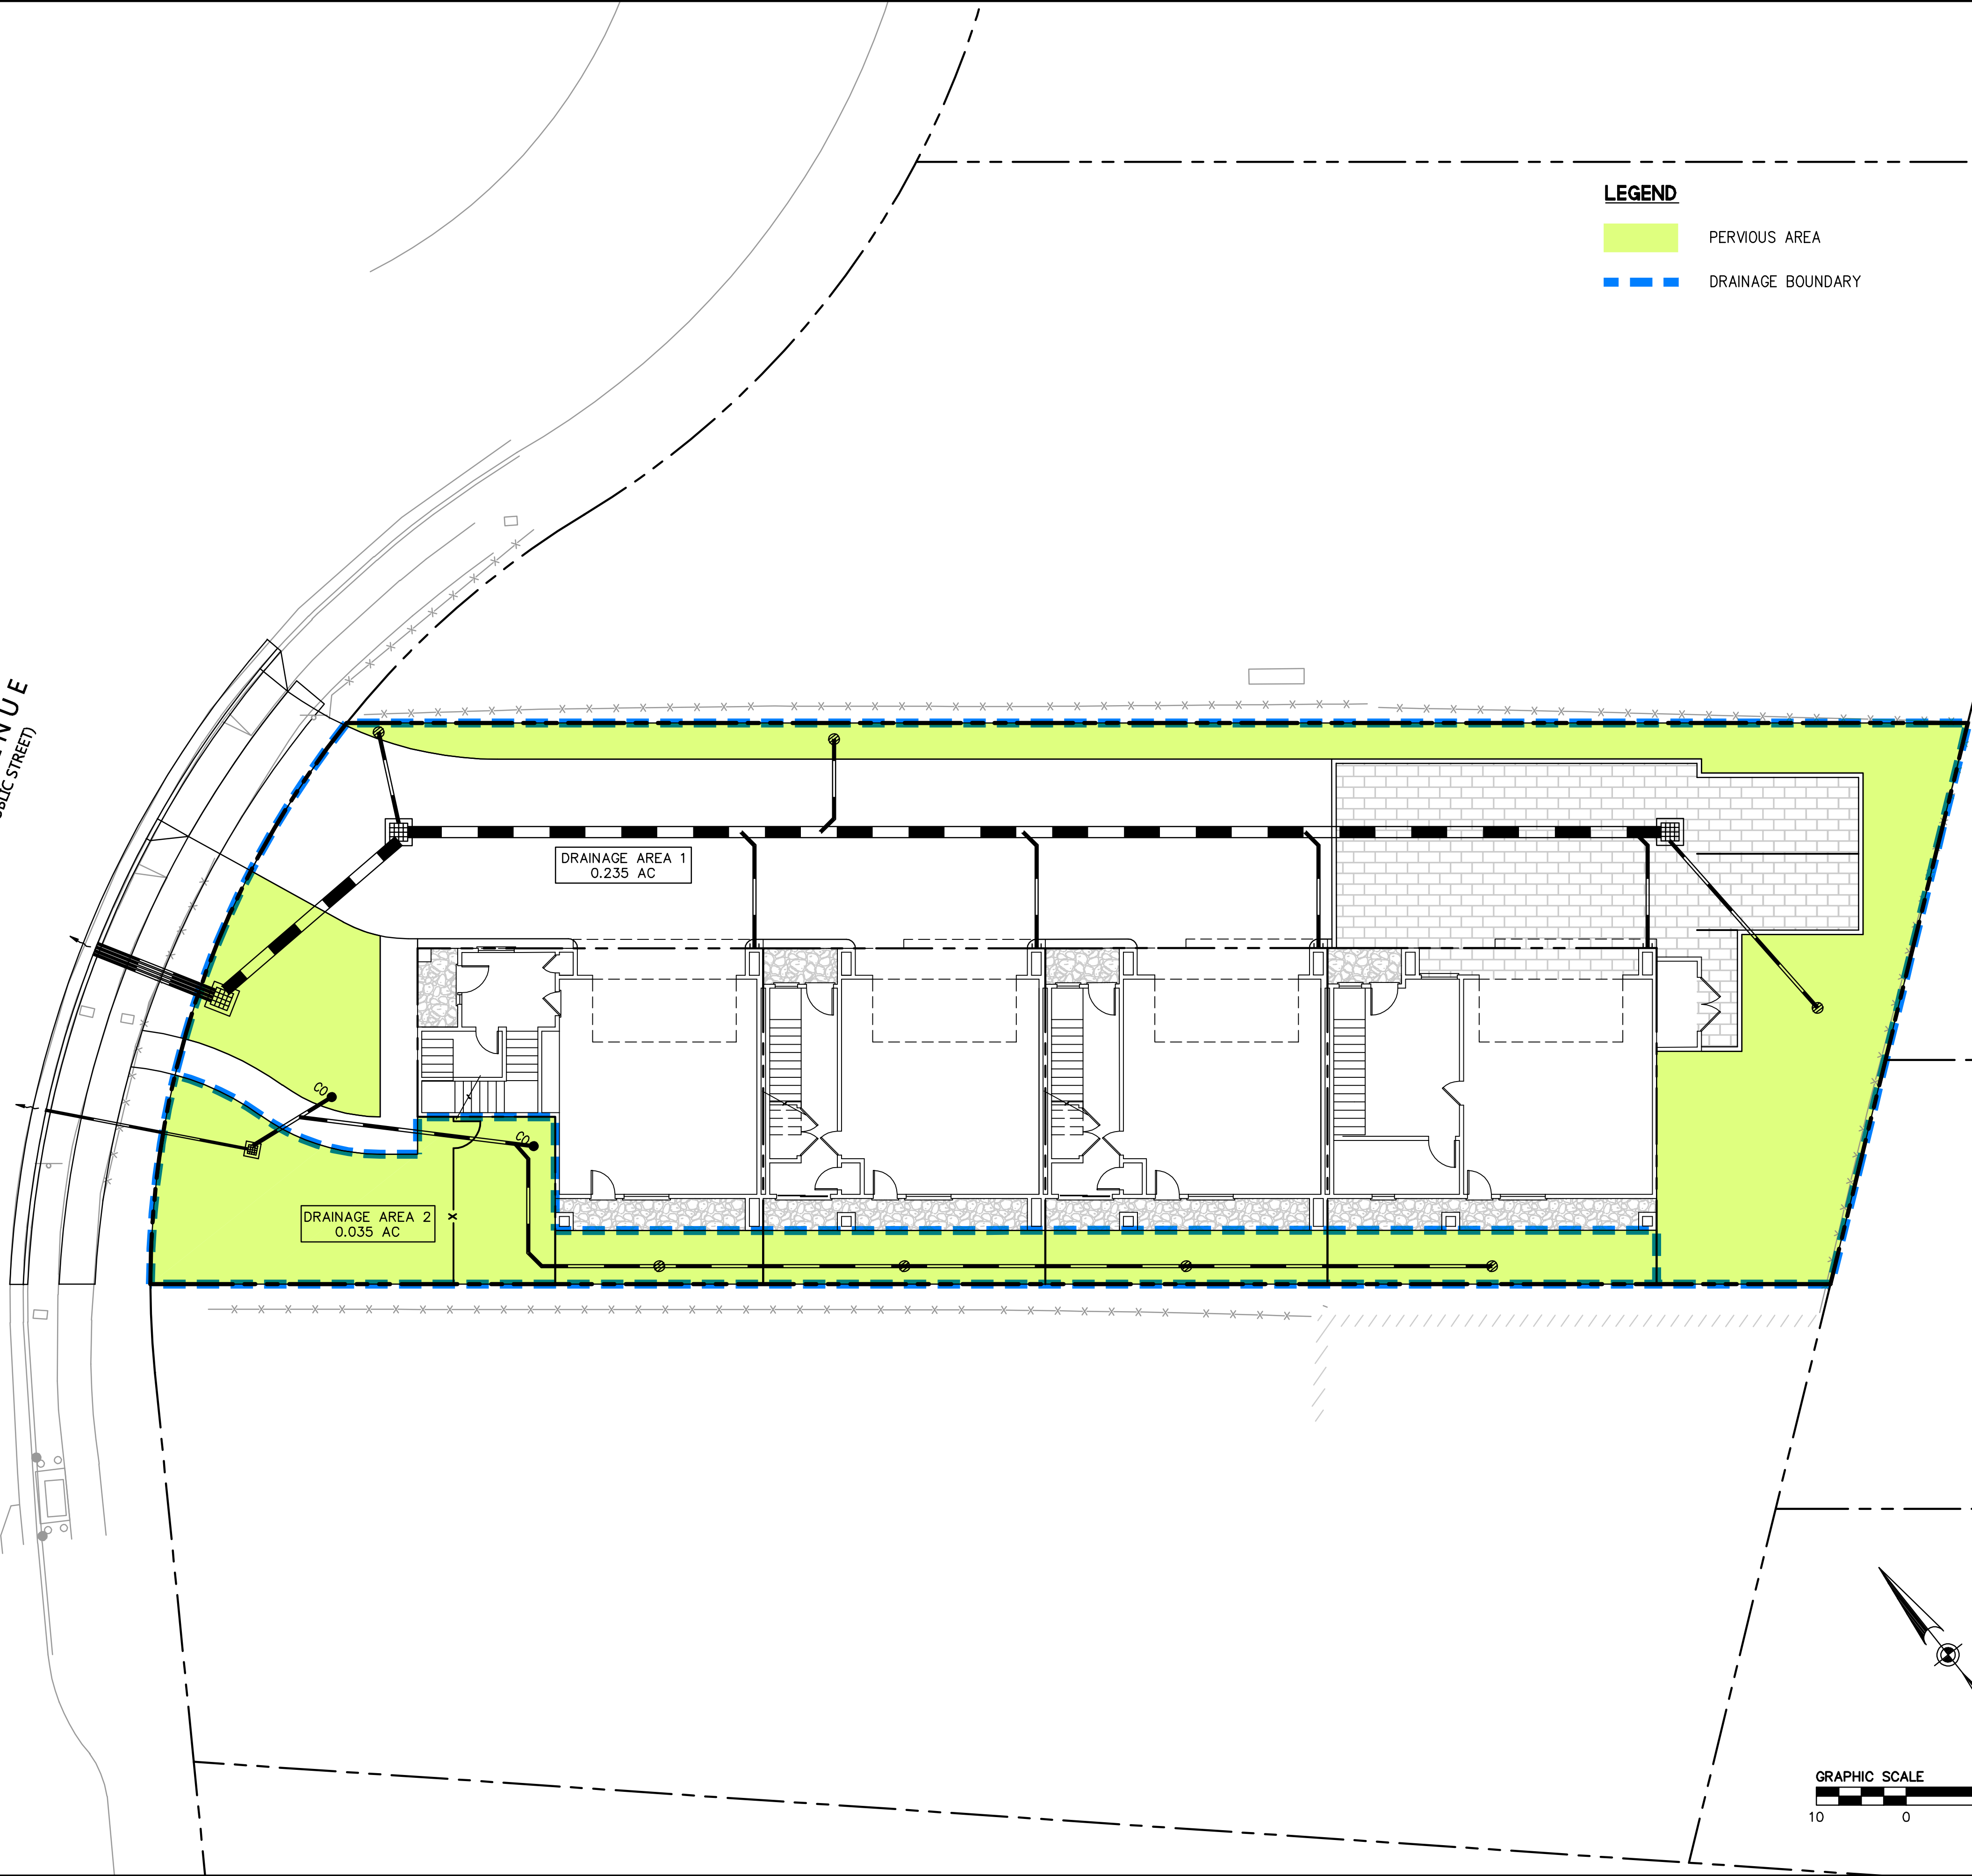

**LEGEND**

- PERVIOUS AREA
- DRAINAGE BOUNDARY

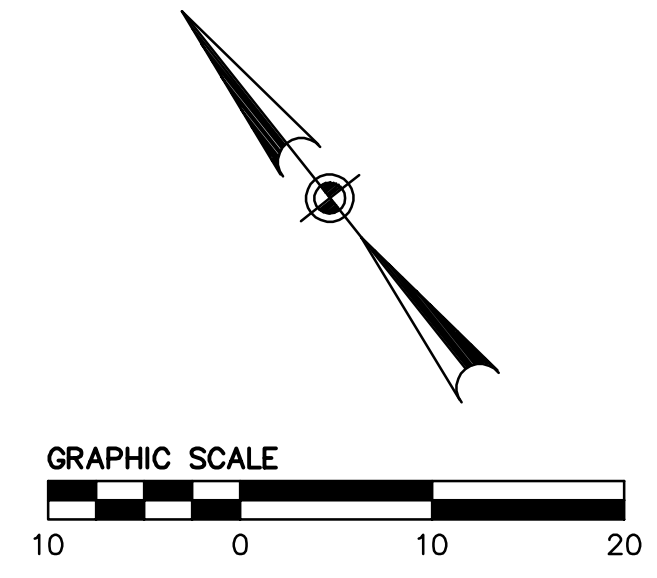

255 SHORELINE DR  
 SUITE 200  
 REDWOOD CITY, CA 94065  
 650-482-6300  
 650-482-6399 (FAX)



**20 DEXTER AVENUE  
 DRAINAGE REPORT  
 PROPOSED DRAINAGE MAP**

REDWOOD CITY  
 SAN MATEO COUNTY  
 CALIFORNIA



DATE SIGNED 06/01/20

Revisions	No.	Date	By

Drawing Number:  
**FIG 1**

Job No. 20190603

County of San Mateo  
Planning and Building Department

**In-Lieu Park Fee Worksheet**

[This formula is excerpted from Section 7055 of the County's Subdivision Regulations]

This worksheet should be completed for any residential subdivision which contains 50 or fewer lots. For subdivisions with more than 50 lots, the County may require either an in-lieu fee or dedication of land.

1. **For the parcel proposed for subdivision, look up the value of the land on the most recent equalized assessment roll. (Remember you are interested in the land only.)**

Value of Land = \$1,422,900

2. **Determine the size of the subject parcel in acres.**

Acres of Land = 0.27

3. **Determine the value of the property per acre.**

- a. **Set up a ratio to convert the value of the land given its current size to the value of the land if it were an acre in size.**



**Formula:**

$$\frac{\text{Parcel Size in Acres (From Item 2)}}{1 \text{ Acre of Land}} = \frac{\text{Value of Subject Parcel (From Item 1)}}{\text{Value of Land/Acre}}$$

**Fill Out:**

$$\frac{0.27}{1 \text{ Acre}} = \frac{\$1,422,900}{\text{Value of Land/Acre}}$$

**b. Solve for X by cross multiplying.**

**Formula:**

$$\text{Value of Land} = \frac{\text{Value of the Subject Parcel (From Item 1)}}{\text{Size of the Subject Parcel in Acres (From Item 2)}} = \underline{\hspace{2cm}}$$

**Fill Out:**

$$\text{Value of Land} = \frac{\$1,422,900}{0.27} = \underline{\hspace{2cm}} \$5,270,000$$

**c. Determine the number of persons per subdivision.**

<b>Formula:</b>			
Number of New Lots Created*	X	3.10**	= Number of Persons Per Subdivision
*Example = A 2-lot split would = 1 newly created lot.			
<b>Fill Out:</b>			
<u>3</u>	X	3.10**	= <u>9.3</u>
**Average number of persons per dwelling unit according to the most recent federal census (2010).			

**d. Determine the parkland demand due to the subdivision.**

<b>Formula:</b>			
Number of Persons Per Subdivision (From Item 4)	X	0.003*** Acres/Person	= Parkland Demand
<b>Fill Out:</b>			
<u>9.3</u>	X	0.003*** Acres/Person	= <u>0.0279</u>
*** Section 7055.1 of the County's Subdivision Ordinance establishes the need for 0.003 acres of parkland property for each person residing in the County.			

e. Determine the parkland in-lieu fee.

**Formula:**

$$\begin{array}{l} \text{Parkland Demand} \\ \text{(From Item 5)} \end{array} \quad \times \quad \begin{array}{l} \text{Value of the Land/Acre} \\ \text{(From Item 3.b)} \end{array} = \begin{array}{l} \text{Parkland} \\ \text{In-Lieu Fee} \end{array}$$

**Fill Out:**

$$\underline{0.0279} \quad \times \quad \underline{\$5,270,000} = \underline{\$147,033}$$